
FIVE STAR EQUIPMENT PROPOSED BUILDING AND SITE IMPROVEMENTS

280 ELLICOTT ROAD

TOWN OF AURORA, ERIE COUNTY STATE OF NEW YORK AUGUST, 2017

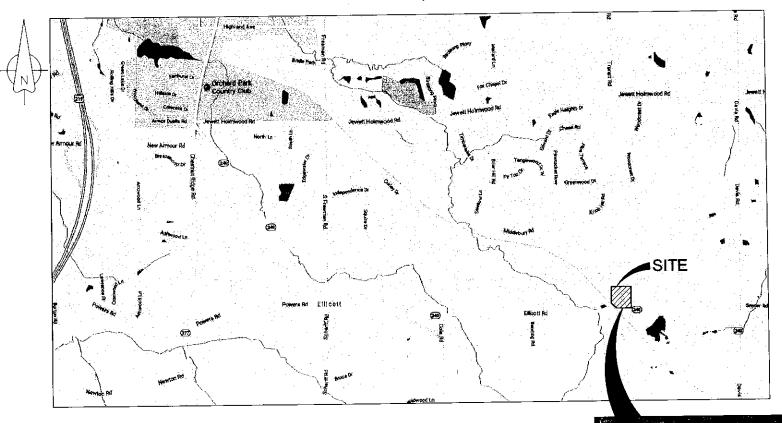

	LIST OF DRAWINGS	
DWG	TITLE	
G-100	COVER SHEET	
C-101	EXISTING CONDITIONS PLAN	
C-102	DEMOLITION PLAN	
C-103	SITE PLAN LAYOUT	
C-104	CRADING AND PAYING PLAN	
C-105	UTILITY PLAN	
C-106	SITE DETAILS 1	
C-107	SITE DETAILS 2	
C-108	BIO-RETENTION BASIN AND DETAILS	
C-109	EROSION AND SEDIMENT CONTROL PLAN	
C-110	EROSION AND SEDIMENT CONTROL DETAILS	
C-111	SEPTIC SYSTEM SITE PLAN AND NOTES	
C-112	SEPTIC SYSTEM DETAILS 1 .	
C-113	SEPTIC SYSTEM DETAILS 2	
C-114	LANDSCAPE PLAN	

LOCATION MAP





**ENGMEERS AND SURVEYORS
3556 LAKE SHORE ROAD
BUFFALO, NY 14219-1494
(716) 827-8000 PHONE
(716) 828-7958 FAX


NOT FOR CONSTRUCTION
AGENCY REVIEW
08-18-17


NUSSBAUMER & CLARKE, INC. A CORPORATION REGISTERED TO PRACTICE PROFESSIONAL ENGINEERING & LAND SURVEYING IN THE STATE OF NEW YORK


CERTIFICATE N

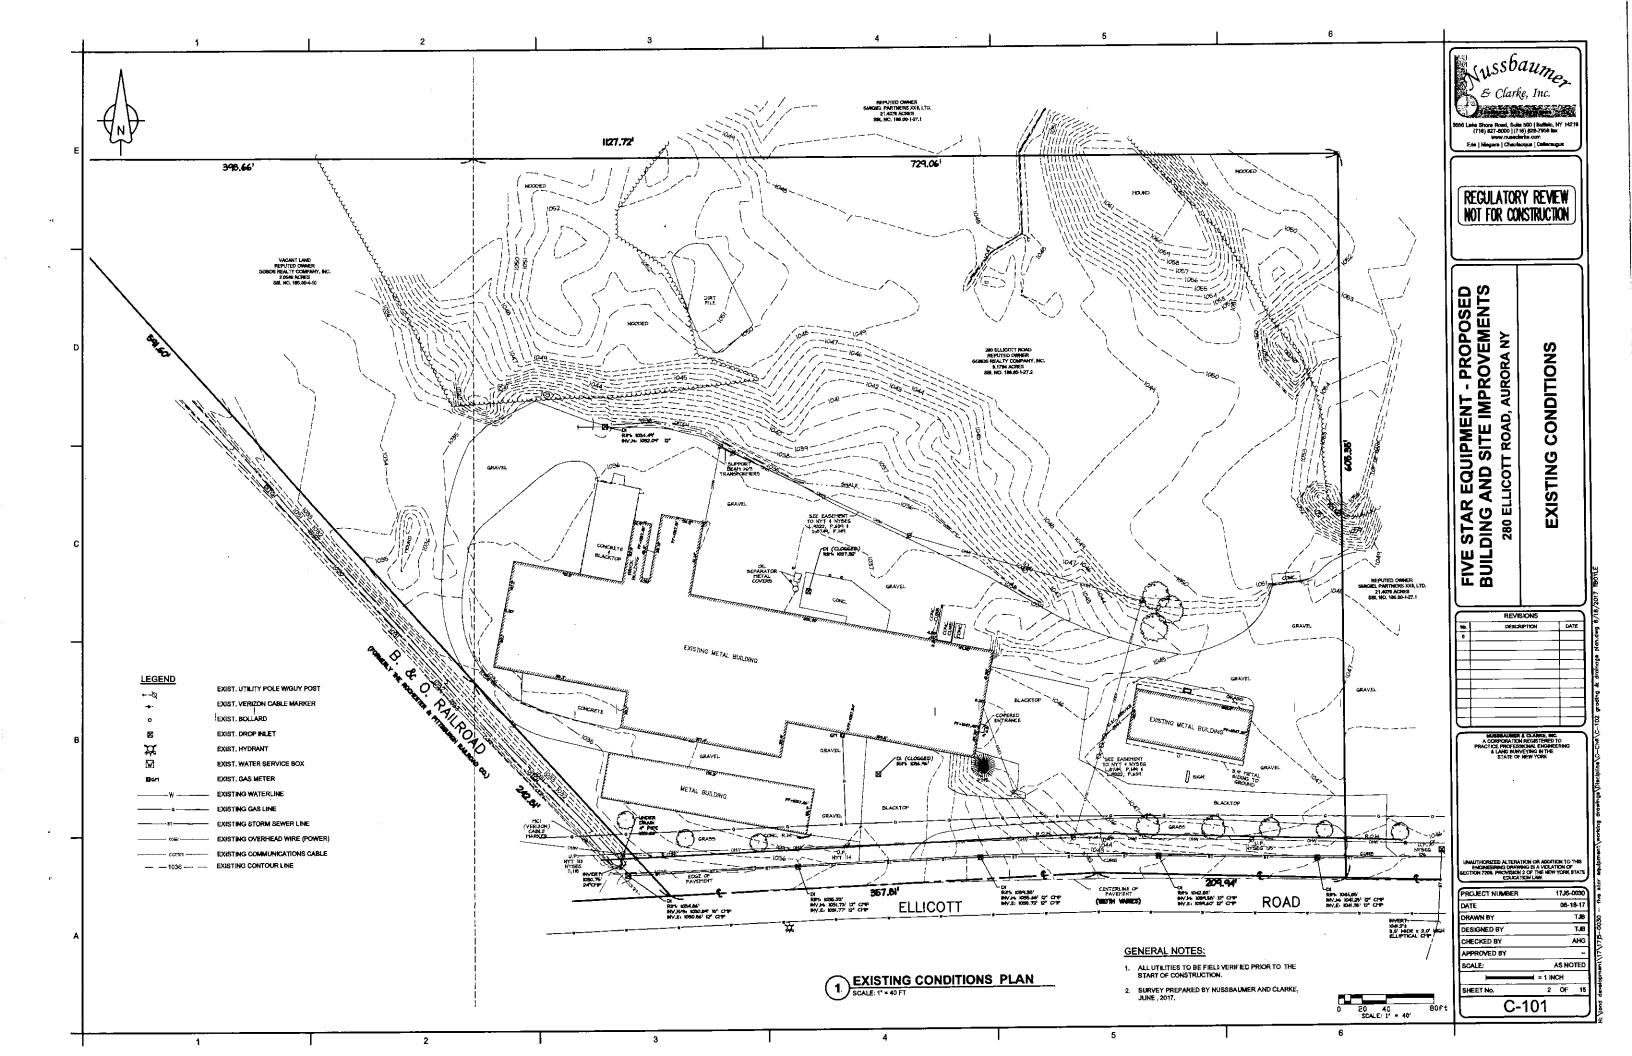

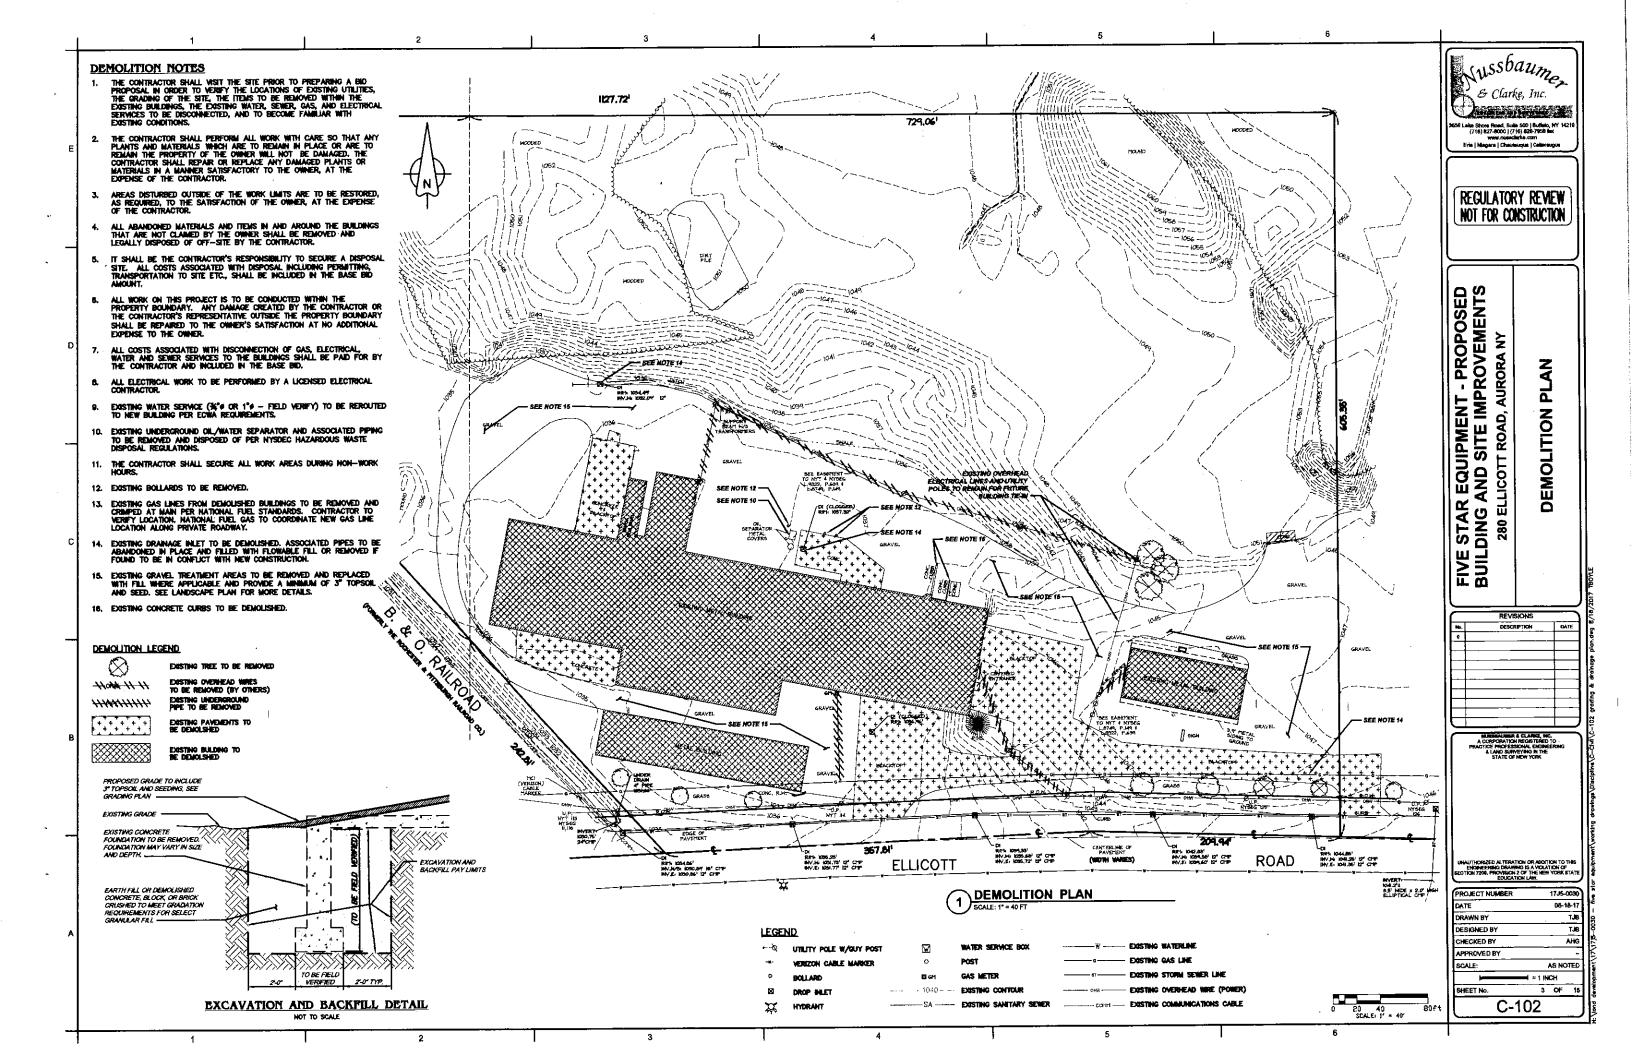

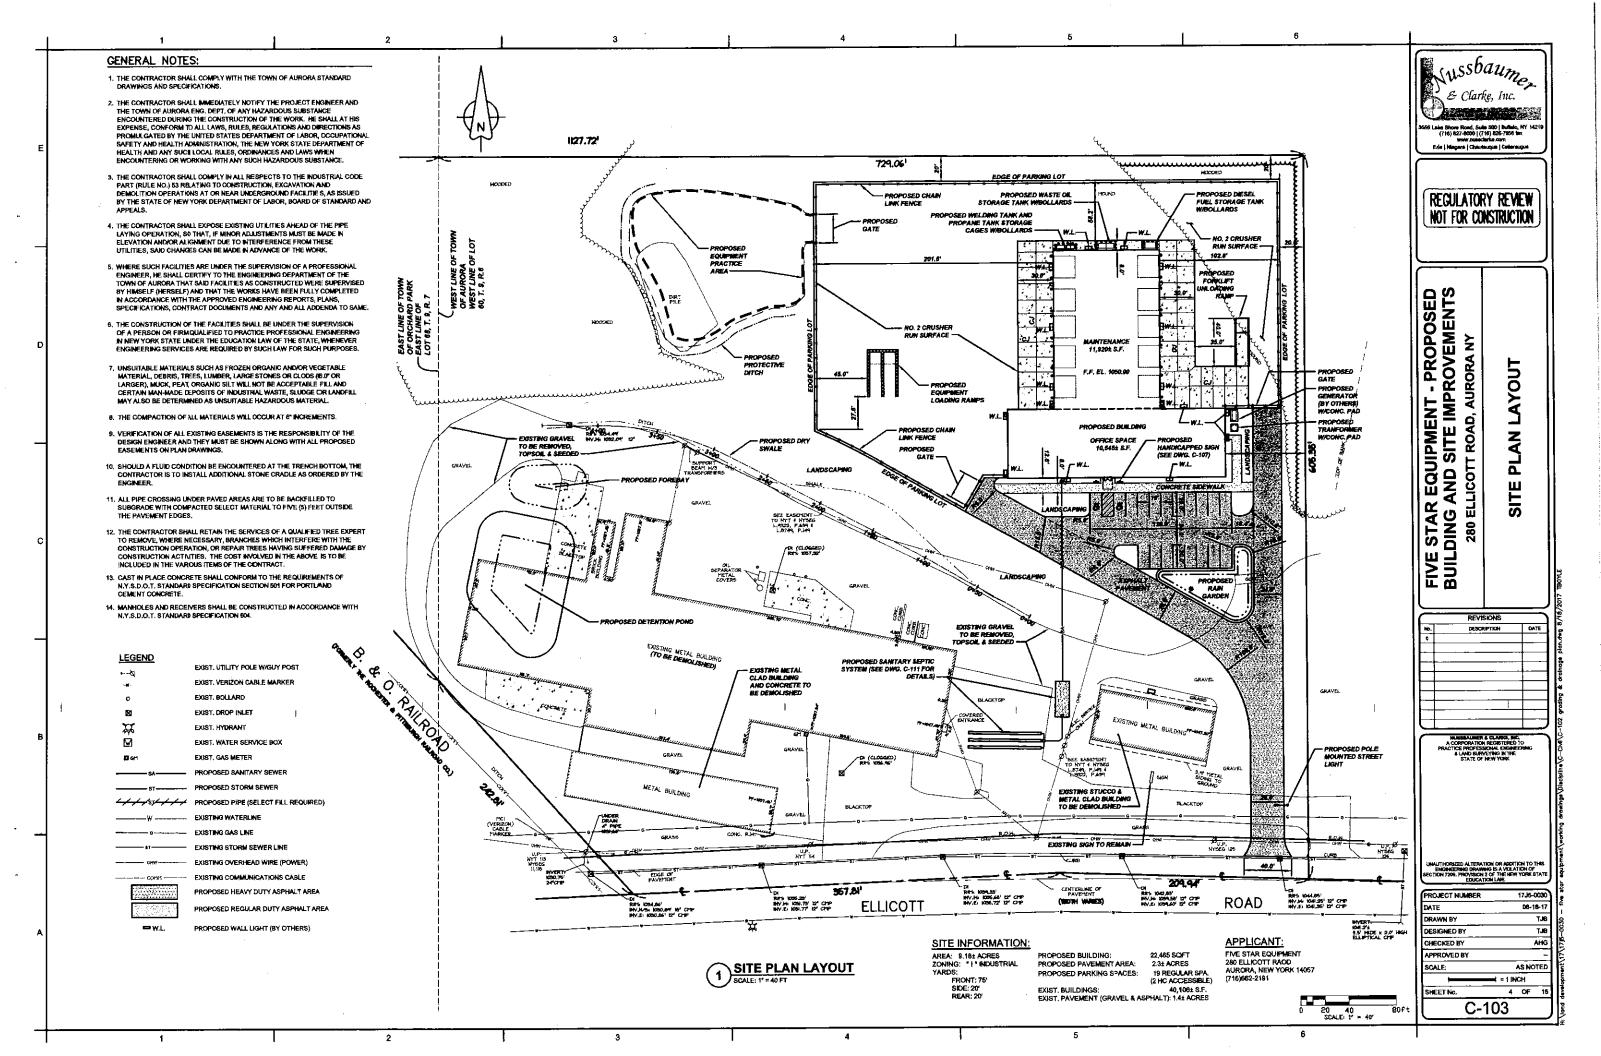


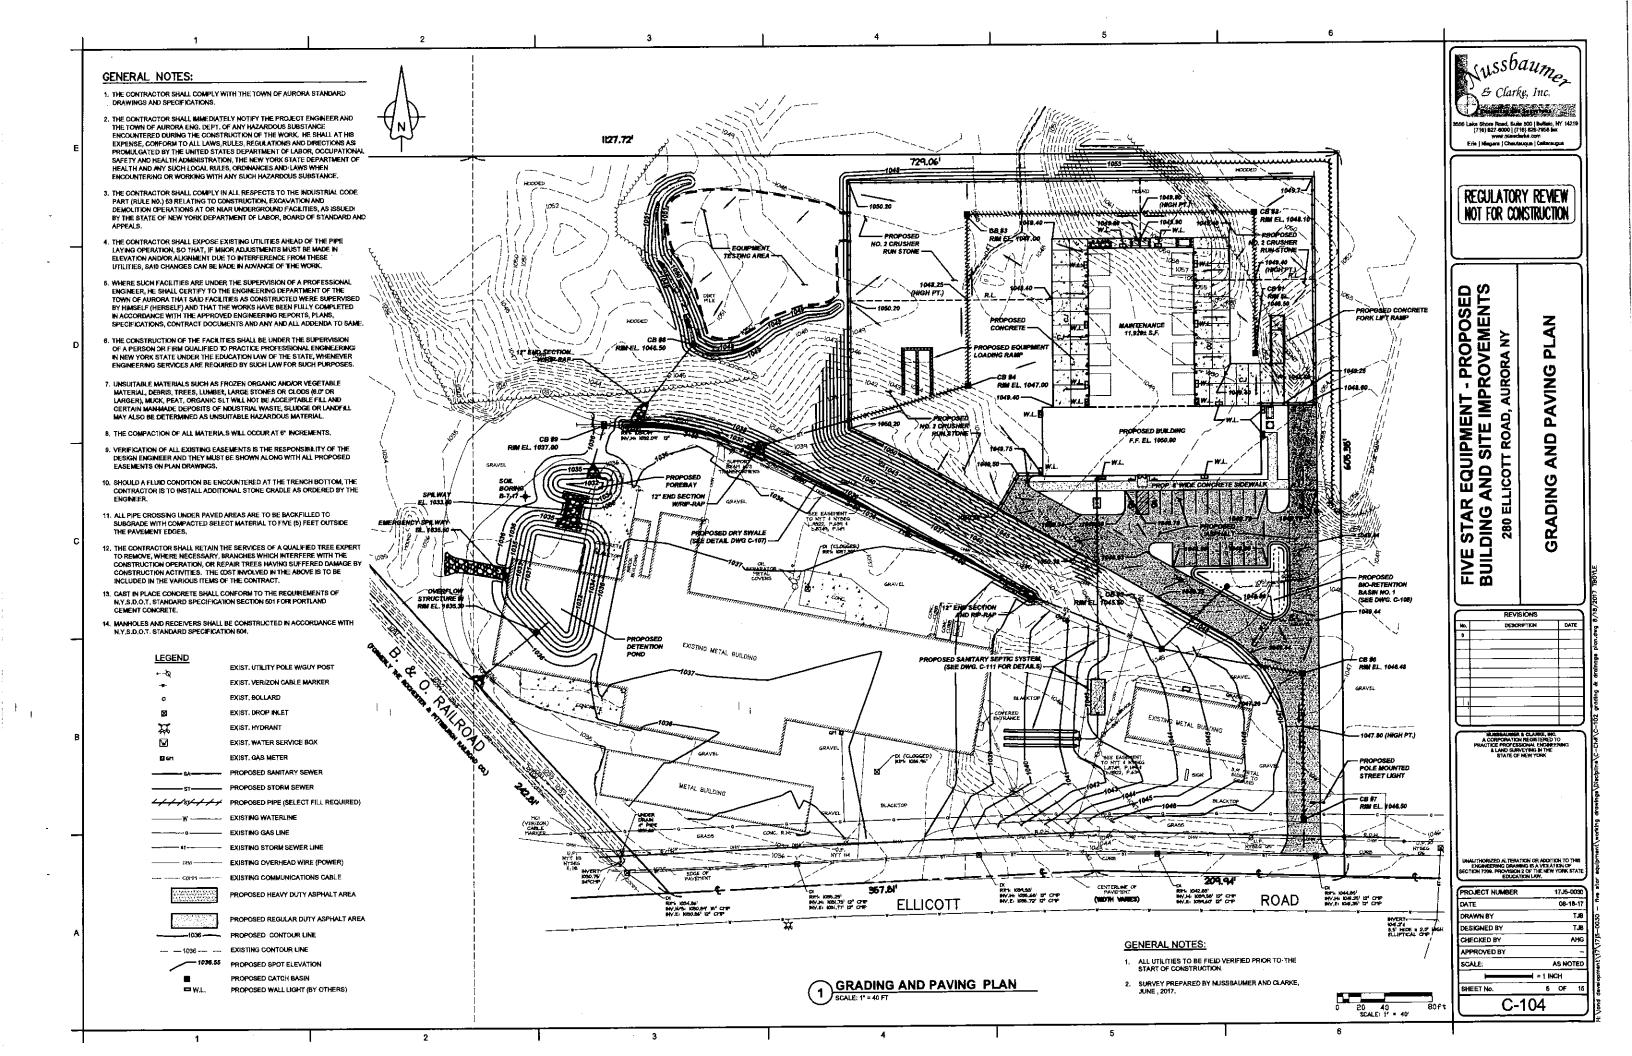

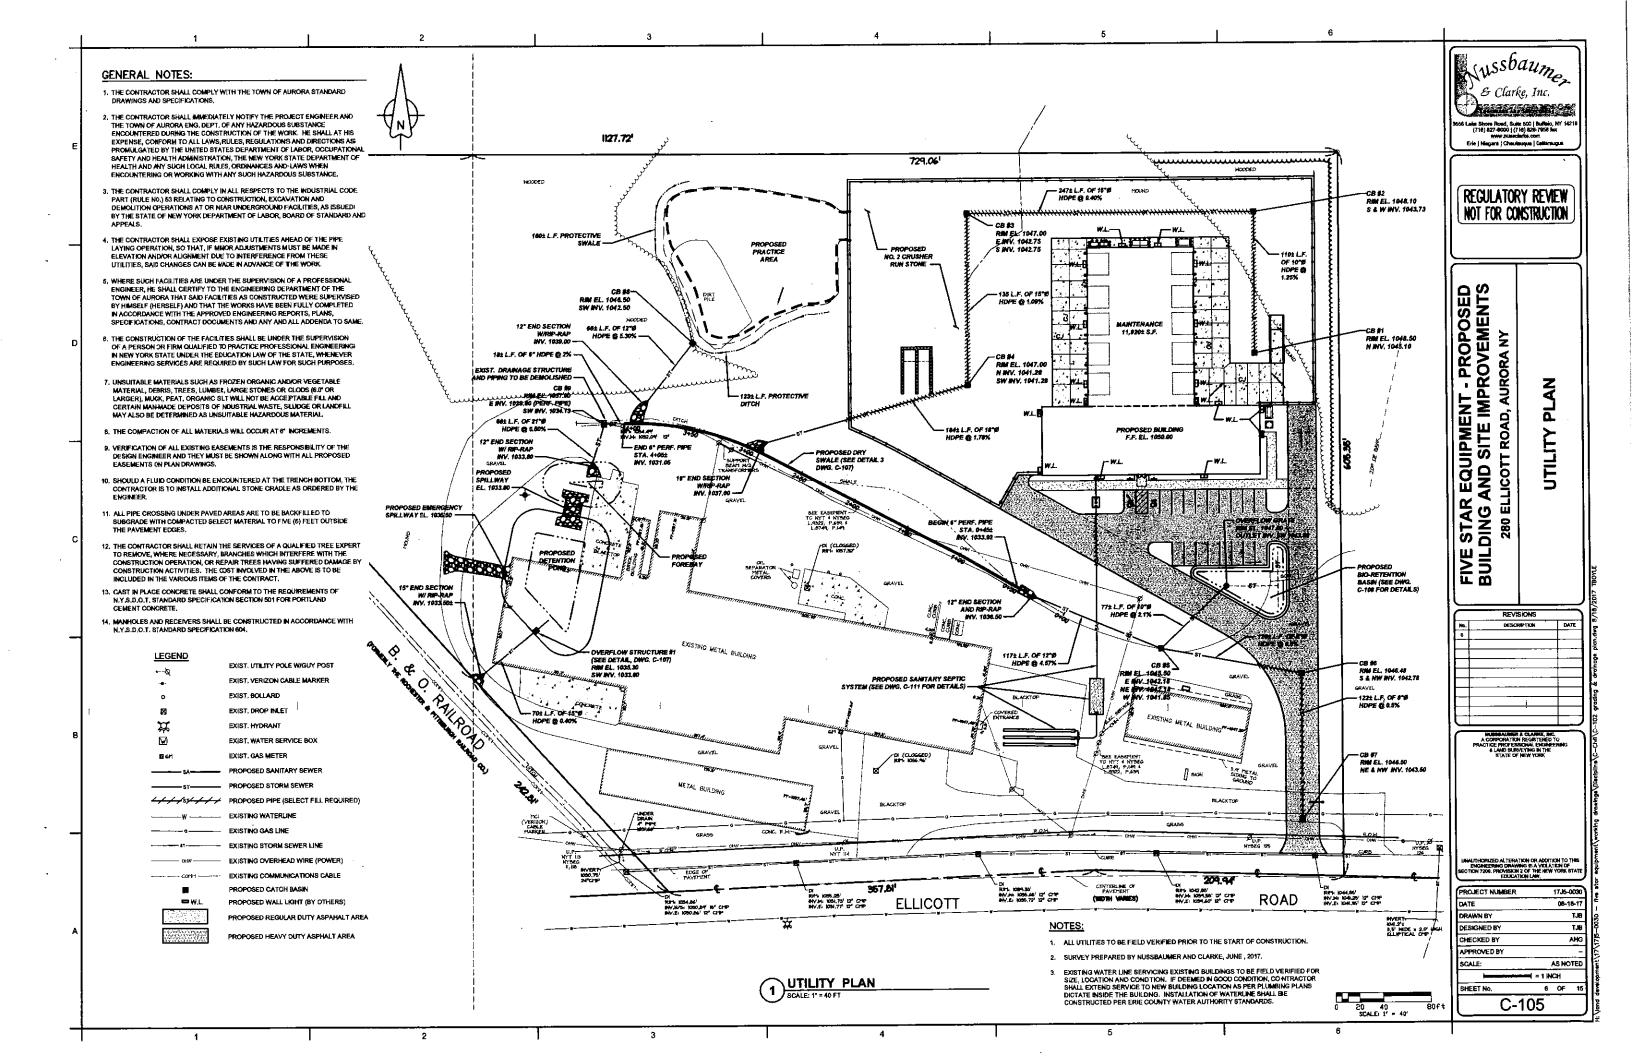

NOTE: THE BINDER AND BASE COURSES MAY CONSIST OF RECYCLED ASPHALT MATERIAL


TYPICAL ASPHALT PAVEMENT SECTION

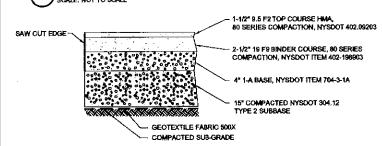

NOTE: THE BINDER AND BASE COURSES MAY CONSIST OF RECYCLED ASPHALT MATERIAL.



HEAVY DUTY ASPHALT PAVEMENT SECTION

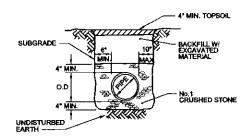

SPECIAL NOTE REGARDING TRENCH BACKFILL MATERIAL:

- SHALE SHALL NOT BE USED AS BACKFILL MATERIAL FOR PIPE CRIOSSINGS OF THE PAVEMENT AND CURBS.
- SHALE SHALL NOT BE PLACED DIRECTLY AGAINST THE UNPROTECTED PIPE SURFACE. A MINIMUM OF 12* OF BEDDING STONE OR SELECT MATERIAL. SHALL OVERLAY THE CROWN OF THE PIPE PRIOR TO PLACEMENT OF SHALE.

MATERIALS USED FOR THE CONSTRUCTION OF CATCH BASINS AIND STORM MANHOLES SHALL MEET THE REQUIREMENTS SPECIFIED IN

CONSTRUCTION OF STORM SEWERS AND UNDERDRAINS SHALL IMEET THE REQUIREMENTS SPECIFIED IN NYSDOT SECTION 603-3 AND: 605-

CONSTRUCTION OF CATCH BASINS AND STORM MANHOLES SHALL MEET THE REQUIREMENTS SPECIFIED IN NYSDOT SECTION 604-31.


MATERIALS USED FOR UNDERDRAIN FILTERMATERIAL SHALL MEET THE REQUIREMENTS SPECIFED IN NYSDOT SECTION 505-2 UNDERDRAIN FILTER

THE CONTRACTOR SHALL SCHEDULE AND CONDUCT HIS/HER OPERATIONS TO MINIMIZE EROSION OF SOILS AND TO MINIMIZE SILTING AND MUDDYING OF STREAMS, RIVERS, IRRIGATION SYSTEMS.
IMPOUNDMENTS (LAKES, RESERVORS, ECT.) AND LANDS ADJACIENT TO/OR AFFECTED BY THE WORK CONSTRUCTION OF DRAINAGE FACILITIES AND PERFORMANCE OF OTHER CONTRACT WORK WHICH WILL CONTRIBUTE TO THE CONTROL OF EROSON AND SEDIMENTATION SHALL BE CARRIED OUT IN CONJUNCTION WITH EARTHWORK OPERATIONS OR AS SOON THEREAFTER

THE CONTRACTOR SHALL NOT DISCHARGE DUST INTO THE ATMOSPHERE OF SUCHOUANTITY, CHARACTER OR DURATION THAT IT UNREASONABLY INTERFERES WITH THE COMFORTABLE ENJOYMENT OF LIFE AND PROPERTY, OR IS HARMFUL TO PLANTS AND ANIMALS.


ALL APPLICABLE REGULATIONS OF FISH, WILDLIFE, AND ENVIRONMENTAL PROTECTION AGENCIES AND STATUTES RELATING TO THE PREVENTION ABATEMENT OF POLLUTION SHALL BE COMPUED WITH.

TYPICAL SECTION FOR EARTH BACKFILL 1 TYPICAL SE

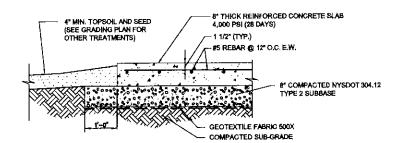


3

TYPICAL CONCRETE PAVEMENT DETAIL

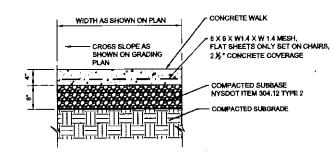

CONCRETE SIDEWALK DETAIL

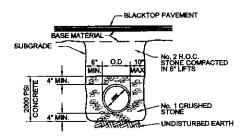

PIPE BEDDING MATERIAL (1)

NO. 1 CRUSHED STONE WITH A GRADATION CONFORMING WITH NYSDOT SECTION 703-02. THE CRUSHED STONE SHALL BE WELL GRADED WITH NO FARTICLES LARGER THAN ONE (1) INCH A NO HAVING A MAXIMUM GRADATION MEETING THE LIMITS DESCRIBED IN THE SPECIFICATIONS. THE BEDDING SHALL BE COMPACTED IN 8" LIFTS WITH EQUIPMENT ACCEPTABLE TO THE PIPE MANUFACTURER. NO SLAG SHALL BE ALLOWED.

- A. PIPE INSTALLATION SHALL BE IN ACCORDANCE WITH MANUFACTURER'S RECOMMENDATIONS.
- TRENCHING OPERATIONS SHALL INCLUDE ALL NECESSARY DEWATE RING.
- TRENCH DETAILS ARE ONLY SHOWN FOR PURPOSES OF MATERIAL PLACEMENT AND MAXIMUM
- AN OSHA APPROVED MOVABLE PROTECTIVE TRENCH SHIELD SHALL BE USED IN ALL UNSHEETED TRENCH AREAS.
- TEMPORARY SHEETING AT CONTRACTOR'S OPTION AND EXPENSE, TEMPORARY SHEETING TO MEET OSHA REQUIREMENT.

PIPE MATERIAL SPECIFICATIONS

- HDPE PIPE CORRUGATED POLYETHYLENE PIPE (8" TO 24" HDPE) SHALL MEET AASHTO M294 SPECS, JOINTS TO BE FIELD JOINED WITH STANDARD SPLIT COUPLERS.
- REINFORCED CONCRETE PPE SHALL BE CLASS III AND MEET ASTM DESIGNATION C-76 SPECS, JOINTS FOR RCP SHALL BE EQUIPPED WITH ROUND RUBBER GASKETS,
- CORRUGATED METAL PIPE SHALL BE ALUMINIZED STEEL TYPE 2 WITH A MINIMUM 16 GUIAGE AND MEET ASTM DESIGN DESIGNATION A-444 SPECS. JOINTS FOR CMP SHALL BE FIELD JOINTED WITH ALUMINIZED METAL BANDS.

TYPICAL SECTION FOR SELECT BACKFILL AND CONCRETE ENCASEMENT STORM TRENCH DETAILS

GENERAL NOTES:

- UNDERGROUND UTILITIES SHOWN ARE APPROXIMATE, IT SHALL BE THE CONTRACTORS RESPONSIBILITY TO HAVE THIS INFORMATION VERIFIED AND LOCATED PRIOR TO CONSTRUCTION.
- WHERE EXISTING UTILITIES ARE REQUIRED TO BE RELOCATED, THE CONTRACTOR SHALL MAKE ALL NECESSARY ARRANGEMENTS WITH THE UTILITY COMPANY CONCERNED REGARDING SUCH RELOCATION. THE COST FOR RELOCATION OF UTILITIES SHALL BE INCLUDED IN THE UN IT PRICES BID FOR PIPE, INSTALLATION AND TRENCHING.
- ALL DEBRIS AND SPOIL SHALL BE REMOVED FROM THE SITE BY THE CONTRACTOR.
- 4. BEFORE YOU DIG OR BLAST IN WESTERN NEW YORK CALL "DIG SAFELY
- SHALE SHALL NOT BE USED AS BACKFILL MATERIAL FOR PIPE CROSSINGS OF THE PAVEMENT AND CURBS.
- PRIOR TO SUBBASE COURSE PLACEMENT, THE SURFACE ON WHICH THE SUBBASE IS TO BE PLACED SHALL BE THOROUGHLY COMPACTED TO THE 95% PROCTOR DENSITY AND PROOF ROLLED, PROOF ROLLING SHALL BE ACCORDANCE WITH SECTION 203-3,02C OF THE NYSDOT STANDARD
- 7. THE PARKING LOT SHALL BE STRIPED AS SHOWN ON THE PLAN
- A NYSDOY HIGHWAY WORK PERMIT IS REQUIRED FOR ANY WORK WITHIN THE STATE R.O.W.

TYPICAL BOLLARD DETAIL

SMOOTH DOMED WASH


W/ BLACK & YELLOW CAUTION STRIPES @ 45*

6% SCHED, 40 STEEL PIPE FILLED N/CONCRETE AND PAINT

CONCRETE, PAVING

18"Ø CONC. BASE


OR GRADE

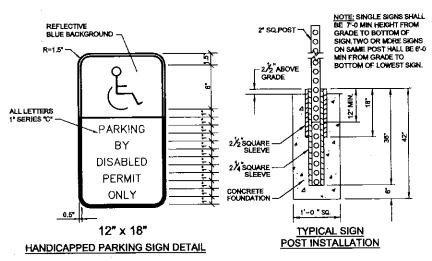

GENERAL HANDICAP SIGN NOTES:

- TOP PORTION OF FTP-25 SHALL HAVE A REFLECTIVE BLUE BACKGROUND WITH WHITE REFLECTIVE SYMBOL AND BORDER.
- BOTTOM PORTION OF FTP-26 SHALL HAVE A REFLECTIVE WHITE BACKGROUND WITH BLACK OPAQUE LEGEND AND
- THP 25 SHALL BE FABRICATED ON ONE PANEL.
 THE SIGN SHALL BE PLACED A MINIMUM OF 3' FROM THE
 WHEEL STOP OR THE BACK OF CURB (WHERE APPLICABLE).

TYPICAL SIGN POST INSTALLATION DETAIL SCALE: NOT TO SCALE

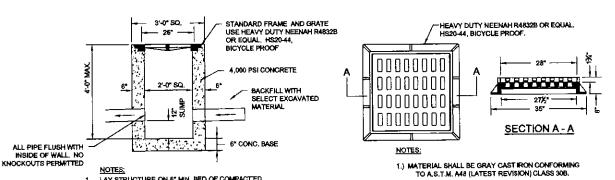

- LAY STRUCTURE ON 6" MIN, BED OF COMPACTED MYSDOT TYPE 2 MATERIAL.
- 2. CATCH BASIN SHALL BE KISTNER 2424 AS RECIUIRED TO ACHIEVE 12" SUMP, OR EQUAL.

CATCH BASIN DETAIL SCALE: NOT TO SCALE

FRAME AND GRATE DETAIL

2.) UNITS DESIGNED HEAVY DUTY FOR A.A.S.H.T.O. HS20-44 WHEEL LOADS.

iussbaume, & Clarke, Inc. 3556 Lake Shore Road, Suite 500 | Buffelo, NY 14 (715) 827-8000 | (716) 828-7956 (ex www.nusecaerce.com
Erie | Niegara | Cheuleuque | Calieraugue

REGULATORY REVIEW NOT FOR CONSTRUCTION

AURORA

₹

ш

 $\overline{\mathbf{o}}$


REQUIPMENT - PROPOSE AND SITE IMPROVEMENT FIVE STAR EQUIP BUILDING AND SI 280 ELLICOTT R

O S


REVISION

PROJECT NUMBER 17.85.0030 DRAWN BY TJB T.JB AHG CHECKED BY APPROVED BY AS NOTED 1 INCH 7 OF 15 SHEET NO

C-106

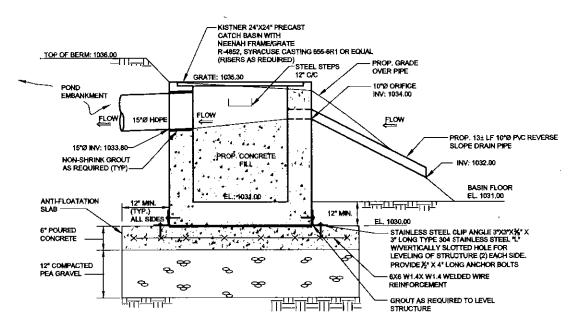

OVERFLOW STRUCTURE NO. 1 DETAIL

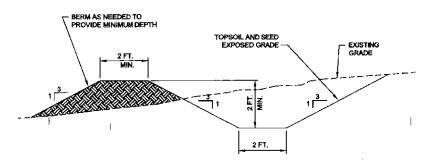


4 SCALE: NOT TO SCALE

	STONE LING ITEM	SEE NOTES	STONE SIZE	PERCENT OF TOTAL BY WEIGHT	NYSDOT ITEM NO.
	MEDIUM	1, 2	HEAVIER THAN 100 POUNDS	50-100	620.04
l	.,,,	.,=	SMALLER THAN 6-INCH	0-10	


NOTES: 1. MATERIALS SHALL CONTAIN LESS TAHN 20 PERCENT OF STONES WITH A RATIO OF MAXIMUM TO MINIMUM DIMENSIONS GREATER THAN THREE.

MATERIALS SHALL CONTAIN A SUFFICIENT AMOUNT OF STONES SMALLER THAN THE AVERAGE STONE SIZE TO FILL IN THE SPACES BETWEEN THE LARGER STONES.

5 MEDIUM STONE RIP-RAP

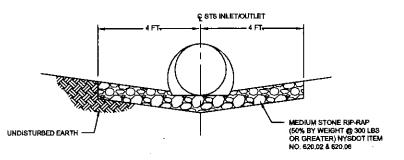

TYPICAL DITCH SECTION

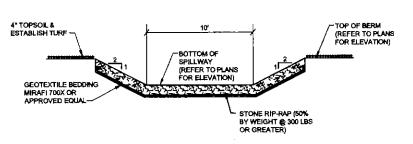

RIP-RAP POND DETAIL

SPILLWAY DETAIL

- THE DRY SWALE SOL MIXTURE. SHALL BE A UNIFORM MIX, FREE DF STONES, STUMPS, ROOTS OR OTHER SIMILAR OBJECTS LARGER THAN TWO BICHES NO OTHER MATERIALS OR SUBSTANCES SHALL BE MIXED OR DUMPED WITHIN THE RAIN GARDEN AREA THAT MAY BE HARMFUL TO PLANT GROWTH, OR PROVE A HINDRANCE OF THE PLANTING OR MAINTENANCE OPERATIONS.
- 2. DRY SWALE SOIL MIX SHALL CONSIST OF THE FOLLOWING:

ITEM	EDMPOSITION BY VOLUME	REFERENCE
PLANTING SOIL	30%	SEE BELOW.
SHREDDED 2X HARDWOOD MULCH	20%	SEE BELOW.
SAND	50%	ASTM C33 FINE AGGREGATE
SAND	50%	ASTM C33 FINE AGGREGATE

THE USDA TEXTURAL CLASSIFICATION OF THE PLANTING SOIL FOR THE DRY SMALE SOIL MORTURE: SHALL BE LOAMY
SAND OR SANDY LOAM. PLANTING SOIL SHALL BE SALVAGED OR FURNISHED. PLANTING SOIL SHALL BE TESTED AND MEET
THE FOLLOWING CRITERIA:

ITEGS	PERCENT BY WEIGHT	CONTEM 1831
SAND (2.0 ~ 0.050 MM)	50 - 85%	AASHTO T88
SILT (0.050 - 0.002 MM)	0 - 50%	AASHTO TEB
CLAY (LESS THAN 0,002 MM)	10-20%	AASHTO TBB
ORGANIC MATTER	1,5 - 10%	AASHTO T194

4. THE TEXTURAL ANALYSIS FOR THE PLANTING SOIL SHALL BE AS FOLLOWS


ASTM £11 SIEVE SIZE	MINIMUM PERCENT PASSING BY MIRIGHT
2 IN.	100
NO. 4	90
NO. 10	80

S. DRY SWALE SOIL MIXTURE SHALL BE TESTED AND MEET THE FOLLOWING CRITERIA

ITEM:	EPITERIA	TES" METHOD
CORRECTED PH	5.5 ~ 7.5	ASTM D4972
MAGNESIUM	MINIMUM 32 PPM	
PHOSPHORUS (PHOSPHATE - PyOs)	NOT TO EXCEED 69 PPM	*
POTASSIUM (K-O)	MINIMUM 78 PPM	1
SOLUBLE SALTS	NOT TO EXCEED 500 PPM	*

6. DRY SWALE SOIL MIXTURE SHALL BE MIXED TO A HOMOGENEOUS CONSISTENCY TO THE SATISFACTION OF THE ENGINEER.

SOIL MIXTURE NOTES

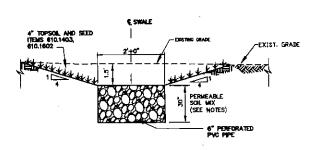

3 DRY SWALE DETAIL SCALE; NOT TO SCALE

sussbaumez & Clarke, Inc. HSS6 Lake Shore Road, Suite 500 | Bullisto, NY 14 (716) 827-8000 | (716) 828-7959 fm;

REGULATORY REVIEW NOT FOR CONSTRUCTION

FIVE STAR EQUIPMENT - PROPOSED BUILDING AND SITE IMPROVEMENTS 280 ELLICOTT ROAD, AURORA NY

LIS

REVISIONS

PROJECT NUMBER DATE 08-18-17 DRAWN BY TJE DESIGNED BY TJB AHG CHECKED BY APPROVED BY SCALE: AS NOTED 1 JNCH SHEET No. 8 OF 15 C-107

BIO-RETENTION BASIN AND FILTER MEDIA NOTES

- THE BIORETENTION SOIL MIXTURE SHALL BE A UNIFORM MIX, FREE OF STONES, STUMPS, ROOTS OR OTHER SIMILAR ORIECTS LARGER THAN TWO INCHES NO OTHER MATERIALS OR SUBSTANCES SHALL BE MIXED OR DUMPED WITHIN THE RAIN GARDEN AREA THAT MAY BE HARMFUL TO PLANT GROWTH, OR PROVE A HINDRANCE TO THE PLANTING OR
- 2. BIORETENTION SOIL MIX SHALL CONSIST OF THE FOLLOWING:

ITEM	COMPOSITION BY VOLUME	REFERENCE
PLANTING SOIL	30%	SEE BELOW.
SHREDDED 2X HARDWOOD MULCH	20%	SEE BELOW,
SAND	50%	ASTM C33 FINE AGGREGATE

3. THE USDA YEXTURAL CLASSIFICATION OF THE PLANTING SOIL FOR THE BIORETENTION SOIL MORTURE SHALL BE LOAM! SAND OR SANDY LOAM, PLANTING SOIL SHALL BE SALVAGED OR FURNISHED. PLANTING SOIL SHALL BE TESTED AND MEET THE FOLLOWING CRITERIA:

ITEM	PERCENT BY WEIGHT	TEST METHOD
SAND (2,0 - 0,050 MM)	50 - 85%	AASHTO T88
SILT (0,050 - 0.002 MM)	0 - 50%	AASHTO T88
CLAY (LESS THAN 0.002 MM)	10-20%	AASHTO TBB
ORGANIC MATTER	1,5-10%	AASHTO T194

4. THE TEXTURAL ANALYSIS FOR THE PLANTING SOIL SHALL BE AS FOLLOWS:

ASTM 611 SIEVE SIZE	MINIMUM PERCENT PASSING BY WEIGHT
2 IN.	100
NO. 4	90
NO. 10	80

5. THE BIORETENTION SOIL MINTURE SHALL BE TESTED AND MEET THE FOLLOWING CRITERIA:

ITEN'	CRITERIA	1EST METHOD
CORRECTED PH	5.5 – 7.5	ASTM D4972
MAGNESIUM	MINIMUM 32 PPM	•
PHOSPHORUS (PHOSPHATE - P2Os)	NOT TO EXCEED 69 PPM	•
POTASSIUM (K,O)	MINIMUM 78 PPM	•
SOLUBLE SALTS	NOT TO EXCEED 500 PPM	•


- USE AUTHORIZED SOIL TEST PROCEDURES.
- 6. THE BIORETENTION SOIL MIXTURE SHALL BE MIXED TO A HOMOGENEOUS CONSISTENCY TO THE SATISFACTION OF THE
- 7. ALL PLANTS, UNLESS OTHERWISE SPECIFICALLY PERMITTED, SHALL CONFORM TO THE STANDARDS OF THE CURRENT EDITION OF AMERICAN STANDARD FOR NURSERY STOCK AS APPROVED BY THE AMERICAN STANDARDS INSTITUTE, INC. ALL PLANT GRADES SHALL BE THOSE ESTABLISHED IN THE CURRENT EDITION OF AMERICAN STANDARDS FOR NURSERY STOCK. ONLY ONE SIZE PER GRADE WILL BE LISTED RATHER THAN A SIZE RANGE. THE ONE SIZE SHALL MEAN THE MINIMUM SIZE FOR THAT GRADE AND SHALL INCLUDE PLANTS FROM THAT SIZE UP TO BUT NOT INCLUDING THE NEXT LARGER GRADE
- 8. ALL PLANT MATERIALS SHALL HAVE NORMAL, WELL DEVELOPED BRANCHES AND A VIGOROUS ROOT SYSTEM. THEY SHALL BE HEALTHY PLANTS FREE FROM PHYSICAL DEFECTS, PLANT DISEASES, AND INSECT PESTS. SHADE AND FLOWERING TREES SHALL BE SYMMETRICALLY BALANCED. MAJOR REANCHES SHALL NOT HAVE V SHAPED CROTCHES CAPABLE OF CAUSING

STRUCTURAL WEAKNESS, TRUNKS SHALL BE FREE OF UNHEALED BRANCH REMOVAL WOUNDS GREATER THAN A 1 IN.

9. SHADE TREES SHALL HAVE A SINGLE MAIN TRUNK, TRUNKS SHALL BE FREE OF BRANCHES BELOW THE FOLLOWING

CALIPER (IN)	HEIGHT (FF)
1-1/2 TO 2-1/2	5
3	6


- 10. PLANT MATERIALS SHALL BE ABLE TO TOLERATE SATURATED SOIL CONDITIONS FOR THE LENGTH OF TIME ANTICIPATED IN THE DESIGN STORM EVENT, AS WELL AS SNOW MELT CHEMICALS AND OTHER ANTICIPATED RUNOFF CONSTITUENTS.
- WATER USED IN THE PLANTING, ESTABLISHING, OR CARING FOR VEGETATION SHALL BE FREE FROM ANY SUBSTANCE THAT IS INJURIOUS TO PLANT LIFE,
- 12. RAIN GARDENS SHALL NOT BE CONSTRUCTED UNTIL ALL CONTRIBUTING DRAINAGE AREAS ARE STABILIZED TO THE SATISFACTION OF THE ENGINEER. RAIN GARDENS SHALL NOT BE USED AS SEDIMENT CONTROL FACULTIES, NO HEAVY EQUIPMENT SHALL OPERATE WITHIN THE PERIMETER OF A RAIN GARDEN DURING EXCAVATION, UNDERDRAIN
- 13. RAIN GARDENS SHALL BE EXCAVATED TO THE DIMENSIONS, SIDE SLOPES, AND ELEVATIONS SHOWN ON THE CONTRACT PLANS. THE METHOD OF EXCAVATION SHALL MINIMIZE THE COMPACTION OF THE BOTTOM OF THE RAIN GARDEN, EXCAVATORS AND BACKHOES SHALL OPERATE ON THE GROUND ADJACENT TO THE RAIN GARDEN TO THE EXTENT POSSIBLE. NO HEAVY EQUIPMENT SHALL BE ALLOWED ON THE BOTTOM OF THE RAIN GARDEN.
- 14. NO HEAVY EQUIPMENT SHALL BE USED WITHIN THE PERIMETER OF THE NAIN GARDENS BEFORE, DURING, OR AFTER THE PLACEMENT OF THE BIORETENTION SOIL MIX. THE BIORETENTION SOIL MIX SHALL BE PLACED IN HORIZONTAL LAYERS NOT TO EXCEED 12 INCHES. THE BIORETENTION SOIL MIX SHALL BE COMPACTED BY SATURATING THE ENTIRE AREA OF THE RAIN GARDEN AFTER EACH LIFT OF BIORETENTION SOIL MIX IS PLACED UNTIL WATER FLOWS FROM THE UNDERDRAIN, WATER FOR SATURATION SHALL BE APPLIED BY SPRAYING OR SPRINKLING. SATURATION OF EACH LIFT SHALL BE PERFORMED IN THE PRESENCE OF THE ENGINEER. AN APPROPRIATE SEDIMENT CONTROL DEVICE SHALL BE USED TO TREAT ANY SEDIMENT-LADEN WATER DISCHARGED FROM THE UNDERDRAIN. IF THE BIORETENTION SOIL MIX BECOMES CONTAMINATED DURING THE CONSTRUCTION OF THE FACILITY, THE CONTAMINATED MATERIAL SHALL BE REMOVED AND REPLACED WITH UNCONTAMINATED MATERIAL AT NO ADDITIONAL COST TO THE OWNER. FINAL GRADING OF THE BIORETENTION SOIL MIX SHALL BE PERFORMED AFTER A 24-HOUR SETTLING PERIOD. FINAL ELEVATIONS SHALL BE WITHIN 2 INCHES OF FLEVATIONS SHOWN ON THE CONTRACT PLANS.
- 15. TREES, SHRUBS, AND OTHER PLANT MATERIALS SPECIFIED FOR BIORETENTION FACILITIES SHALL BE PLANTED AS SPECIFIED IN THE CONTRACT PLANS AND APPLICABLE LANDSCAPING STANDARDS WITH THE EXCEPTION THAT PESTICIDES. HERBICIDES, AND FERTILIZER SHALL NOT BE APPLIED DURING PLANTING UNDER ANY CIRCUMSTANCES. FURTHERMORE, PESTICIDES, FERTILIZER, AND ANY OTHER SOIL AMENDMENTS SHALL NOT BE APPLIED TO THE RAIN GARDENS DURING LANDSCAPE CONSTRUCTION, PLANT ESTABLISHMENT, OR MAINTENANCE,
- 16. CACE PLANTS ARE IN PLACE, RAIN GARDENS SHALL BE MULCHED TO A UNIFORM THICKNESS OF 3 INCHES. THIS SHOULD BE DONE IMMEDIATELY AFTER GRADING TO REDUCE POTENTIAL OF ANY SILT ACCUMULATION ON SURFACE.
- 17. TWO TIMES SHREDDED HARDWOOD BARK SHALL CONSIST OF THE BARK FROM HARDWOOD TREES WHICH HAS BEEN MILLED AND SCREENED TO A MAXIMUM 4 IN, PARTICLE SIZE AND PROVIDE A UNIFORM TEXTURE FREE FROM SAWDUST, FOREIGN MATERIALS, AND ANY ARTIFICIALLY INTRODUCED CHEMICAL COMPOUNDS THAT WOULD BE DETRIMENTAL TO
- 18. PLANT MATERIALS WILL BE MEASURED AND PAID FOR AT THE CONTRACT UNIT PRICE PER EACH ITEM SPECIFIED IN THE CONTRACT DOCUMENTS. THE PAYMENT WILL BE FULL COMPRESSATION FOR ALL SUPPORTS, WATERING DURING THE CONSTRUCTION PERIOD AND FOR ALL MATERIAL LABOR, EQUIPMENT, TOOLS, AND INCIDENTALS NECESSARY TO COMPLETE THE WORK. IF AT ANY TIME DURING THE CONTRACT PERIOD ANY PLANTS BECOME UNACCEPTABLE, THEY SHALL BE REPLACED AT NO ADDITIONAL COST TO THE OWNER.

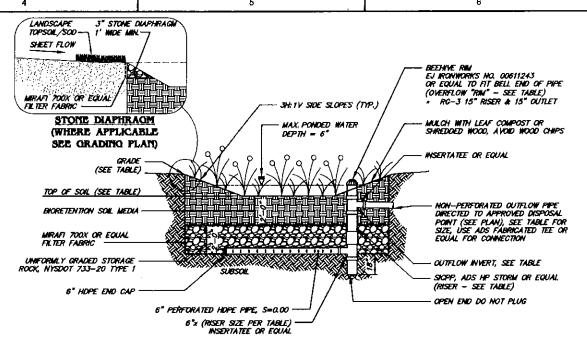

BIO-RETENTION BASIN DETAIL

BIO-RETEN	tion basin no. 1 table
RADE (RIM ELEVATION)	1046,80
MINIMUM AREA (SF)	2,653
OVERFLOW GRATE (FT)	1048.30
riser pipe dia. (in)	18.5
DUTFLOW PIPE SIZE (IN)	10
DUTELOW INVERT (FT)	1043,80
TOP OF SOIL (FT)	1047.80
BOTTOM OF STONE (FT)	1043.80

		PLANTING SCHEDU	LE			
	SHRUBS					
KEY	QUANTITY	BOTANICAL NAME	COMMON NAME	MINNHUM SIZE		
co	19	CEPHALANTHUS OCCIDENTALIS	BUTTON BUSH	24"		
		PERE	NNIALS	· -		
IV	300	IRIS VERSICOLOR	BLUE FLAG IRIS	QUART		
LC	425	LOBELIA CARDINALIS	CARDINAL FLOWER	QUART		

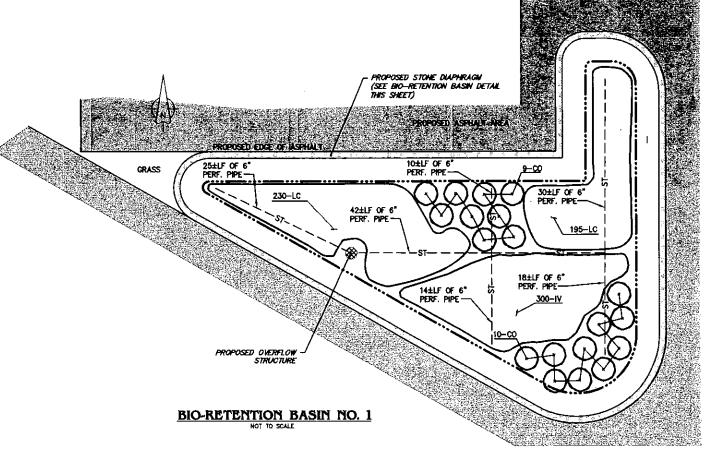




REGULATORY REVIEW NOT FOR CONSTRUCTION

S REQUIPMENT - PROPOSED AND SITE IMPROVEMENTS ₹ Ш AND Z ROAD, S

 $\mathbf{\omega}$ ELLICOTT ENTION 280 ᇤ 交 Ó 面

FIVE STAR E BUILDING A

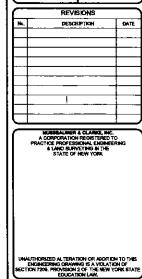

PROJECT NUMBER

DATE

DRAWN BY

DESIGNED BY

CHECKED BY APPROVED BY

SCALE:

SHEET No

17,15-0030

08-18-17

AS NOTED


8 OF 15


= 1 INCH


C-108

TJE

T,JB AHG

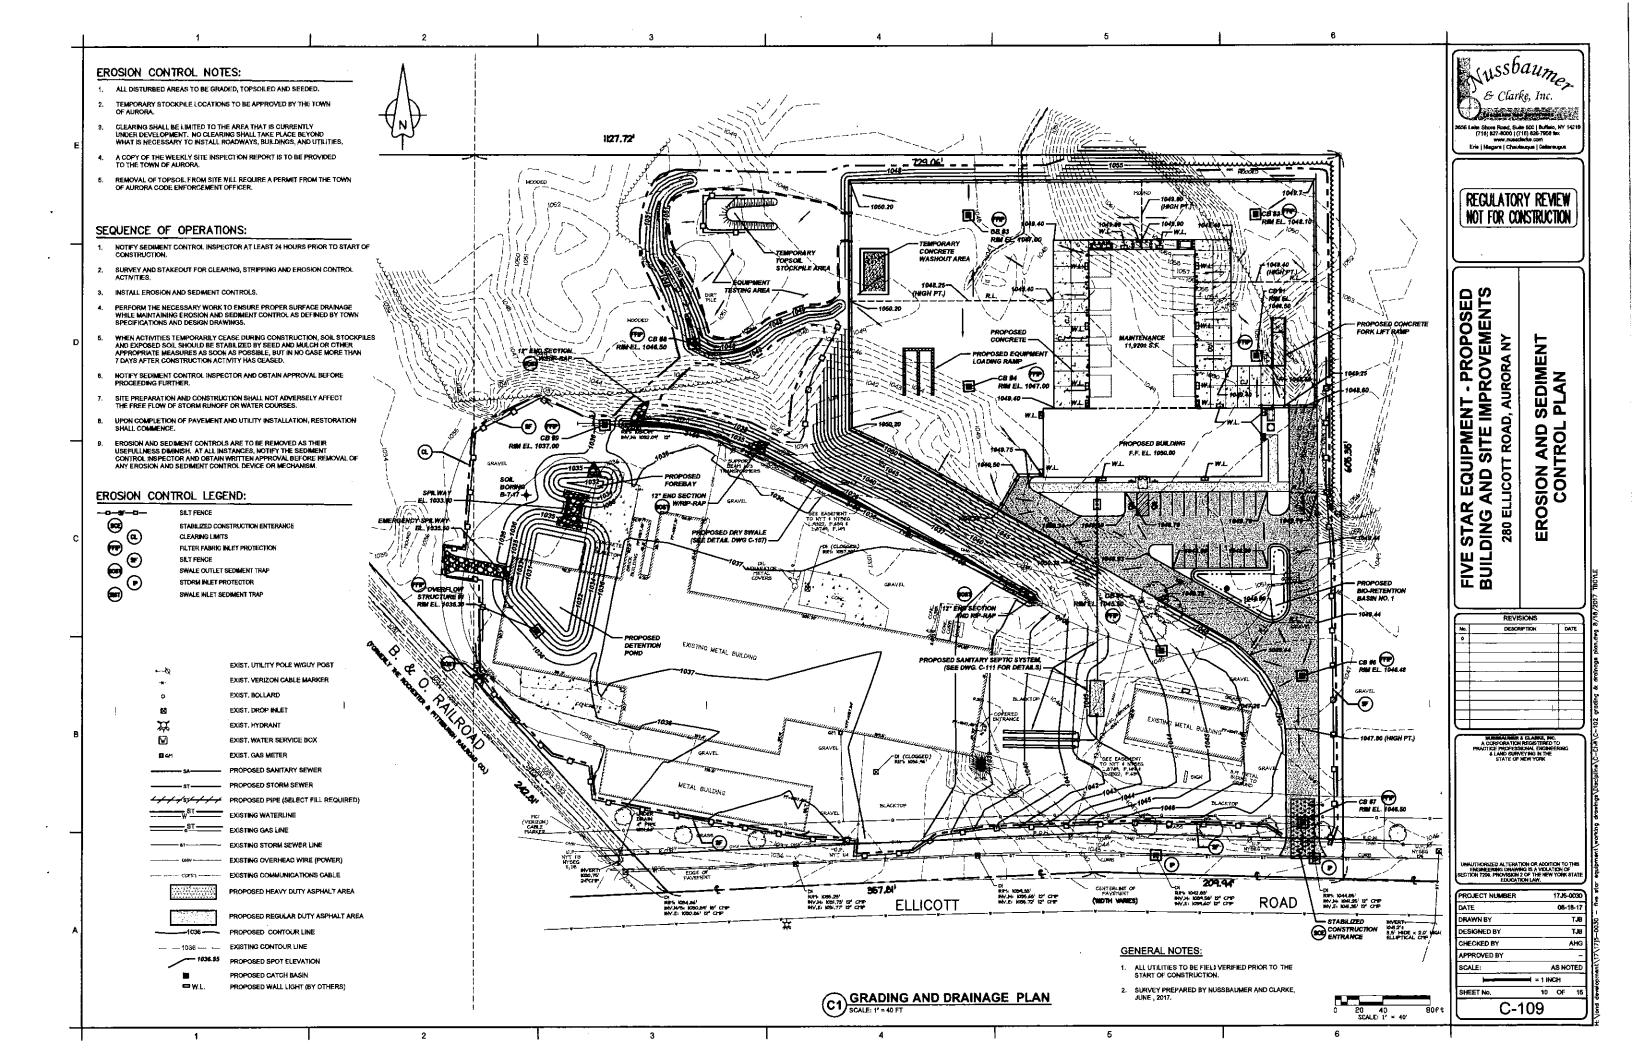

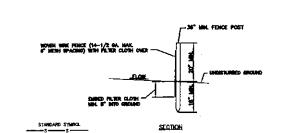

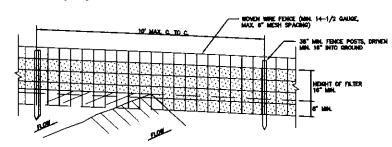

PERSPECTIVE VIEW

CONSTRUCTION SPECIFICATIONS


- WOVEN WIRE FENCE TO BE FASTENED SECURELY TO FENCE POSTS WITH WIRE THES OR STAPLES.

- MAINTENANCE SHALL BE PERFORMED AS NEEDED AND MATERIAL RELIGIVED WHEN "BULGES" DEVELOP IN THE SILT FENCE.


POSTS: STEEL ETHER T OR U TYPE OR 2"X2" HARDWOOD.

PREFABRICATED UNIT: GEOFAB, ENVIROFENCE, OR APPROVED EQUAL NOTE: CONTRACTOR'S OPTION TO SUBSTITUTE "FULTREDO" SEDIMENT CONTROL WHERE APPLICABLE, SEE DETAIL THIS SHEET, SILT FENCE DETAILS
SCALE: NOT TO SCALE

SF

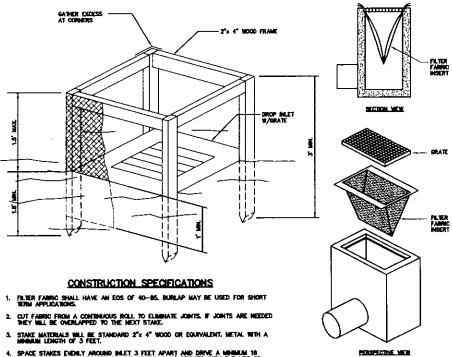

- 5, FABRIC SHALL BE EMBEDDED 1 FOOT MINIMUM BELOW GROUND AND SHALL BE SECURELY FASTENED TO THE STAKES AND FRAME.
- 8. A $2^{\prime\prime}x$ 4" WOOD FRAME SHALL BE COMPLETED AROUND THE CREST OF FOR ONER FLOW STABILITY. MAXIMUM DRAINAGE AREA 1 ACRE

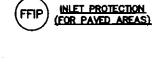

- 2°X 2° X 36° WOODEN STAKES PLACED 10°.0°.C.

FILTREXX®, SØXX™ (12° TÝPICAL)

NOTES:

1. ALL MATERIAL TO MEET FILTREXX SPECIFICATIONS
2. FILTER MEDIAM FILL TO MEET APPLICATION
REQUIREMENTS.

3. COMPOST MATERIAL TO BE DISPERSED ON SITE, AS DETERMINED BY ENGINEER.



SECTION NTS


- 21X 2" X 36" WOODEN STAKES PLACED 10" O.C.

AREA TO BE PROTECTED

BLOWN/PLACED FILTER MEDIA?


WATER FLOW

WORK AREA

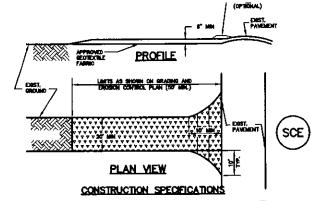

- 1. STONE SIZE USE 2" STONE, OR RECLAIMED OR RECYCLED CONCRETE EQUIVALENT.
- 2. LENGTH AS REQ'D, BUT NOT LESS THAN 50 FEET (EXCEPT ON A SINGLE RESIDENCE LOT WHERE A 30 FOOT MINIMAUM LENGTH WOULD APPLY).
- 3. THICKNESS NOT LESS THAN SIX (6) INCHES.
- 4. WIDTH TEN (10) FOOT MINIMUM, BUT NOT LESS THAN THE FULL WIDTH AT POINTS WHERE INGRESS OR EGRESS OCCURS.
- 5. FILTER CLOTH WILL BE PLACED OVER THE ENTIRE AREA PRIOR TO PLACING OF STONE, FILTER WILL NOT BE REQ'D ON A SINGLE FAMILY RESIDENCE LOT.
- MANTENANCE THE ENTRANCE SHALL BE MANTANED IN A CONDITION WHICH WILL PREVENT TRACKING OR FLOWING OF SEDMENT ONTO PUBLIC TROHTS—OF—WAY, THIS MAY REQUIRE PERFORDIC TOP RESSING WITH AND TIONAL STONE AS CONDITIONS DEMAND AND REPAIR AND/OR CLEANOUT OF MAY MEASURES USED TO TRAP SEDMENT. ALL SEDMENT SEDULED, ROOPPED, WASHED OR TRACKED ONTO PUBLIC RICHT—OF—WAY MUST HE REMOVED MANEDIATELY.

6 STABILIZED CONSTRUCTION ENTRANCE DETAILS

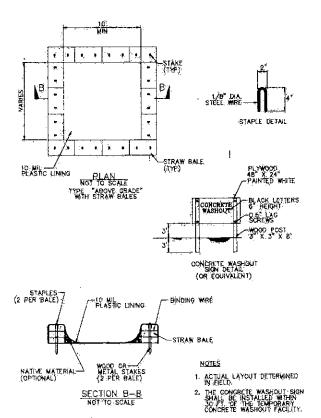





iussbaume, & Clarke, Inc.

REGULATORY REVIEW

NOT FOR CONSTRUCTION

REVISIONS

FIVE

08-18-1 DRAWN BY TJE TJB DESIGNED BY CHECKED BY AHG APPROVED BY SCALE: AS NOTED 11 OF 15

CONCRETE TRUCK WASHOUT DETAIL
SCALE: NOT TO SCALE

EROSION CONTROL NOTES

FILTER FABRIC INLET PROTECTIO

EROSION CONTROL LEGEND

SF SALT FENCE


INLET PROTECTION


- CLEARING SHALL RE LIMITED TO THE PHASE THAT IS CURRENTLY LINGER DEVELOPMENT, "NO CLEARING SHALL TAKE PLACE BEYONG WHAT IS RECESSARY TO INSTALL UTILITIES.
- 4. A copy of the weighty site inspection report is to be provided to the town if reduired.


GENERAL NOTES

- UNDERGROUND UTILITIES SHOWN ARE APPROXIMATE. IT SHALL BE THE CONTRACTORS RESPONSIBILITY TO HAVE THIS INFORMATION VORFIED AND LOCATED PRIOR TO CONSTRUCTION.
- WHERE EXISTING LITE/THES ARE REQUIRED TO BE RELOCATED, THE CONTRACTOR SHALL MAKE ALL RECESSARY ARRANGEMENTS WITH THE LITELITY COMPANY CONCERNED RESAMBING SUCH RELOCATION. THE COST FOR RELOCATION OF LITELITES SHALL BE INCLUDED IN THE LINT PRICES BID FOR PIPE, INSTALLATION AND TREMCHING.
- BEFORE YOU DIG OR BLAST ON WESTERN NEW YORK CALL "DIG SAFELY NEW YORK "1-800-882-7962.
- 5. SHALE SHALL NOT BE USED AS BACKFILL MATERIAL FOR PIPE OF THE PAYMENT AND CURBS.
- B. THE PANISHIS LOT SHALL BE STIMPED AS SHOWN ON THE PLAN.
- A HYSDOT HIGHWAY WORK PERMIT IS REQUIRED FOR ANY WORK WITHIN THE STATE R.O.W.

1/2 LENGTH SILT FENCE TO BE PLACED 1/2 LENGT OF STOCKPILE MIN. OR AS SHOWN LONGITUDINAL MEW

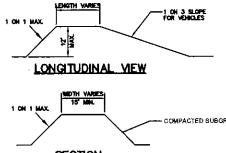

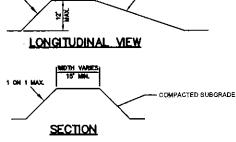

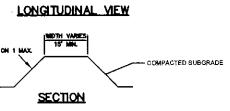



TOPSOIL STOCKPILE DETAILS
SCALE: NOT TO SCALE

FILTREXX® SEDIMENT CONTROL
SCALE; NOT TO SCALE

PLAN NT

C-110

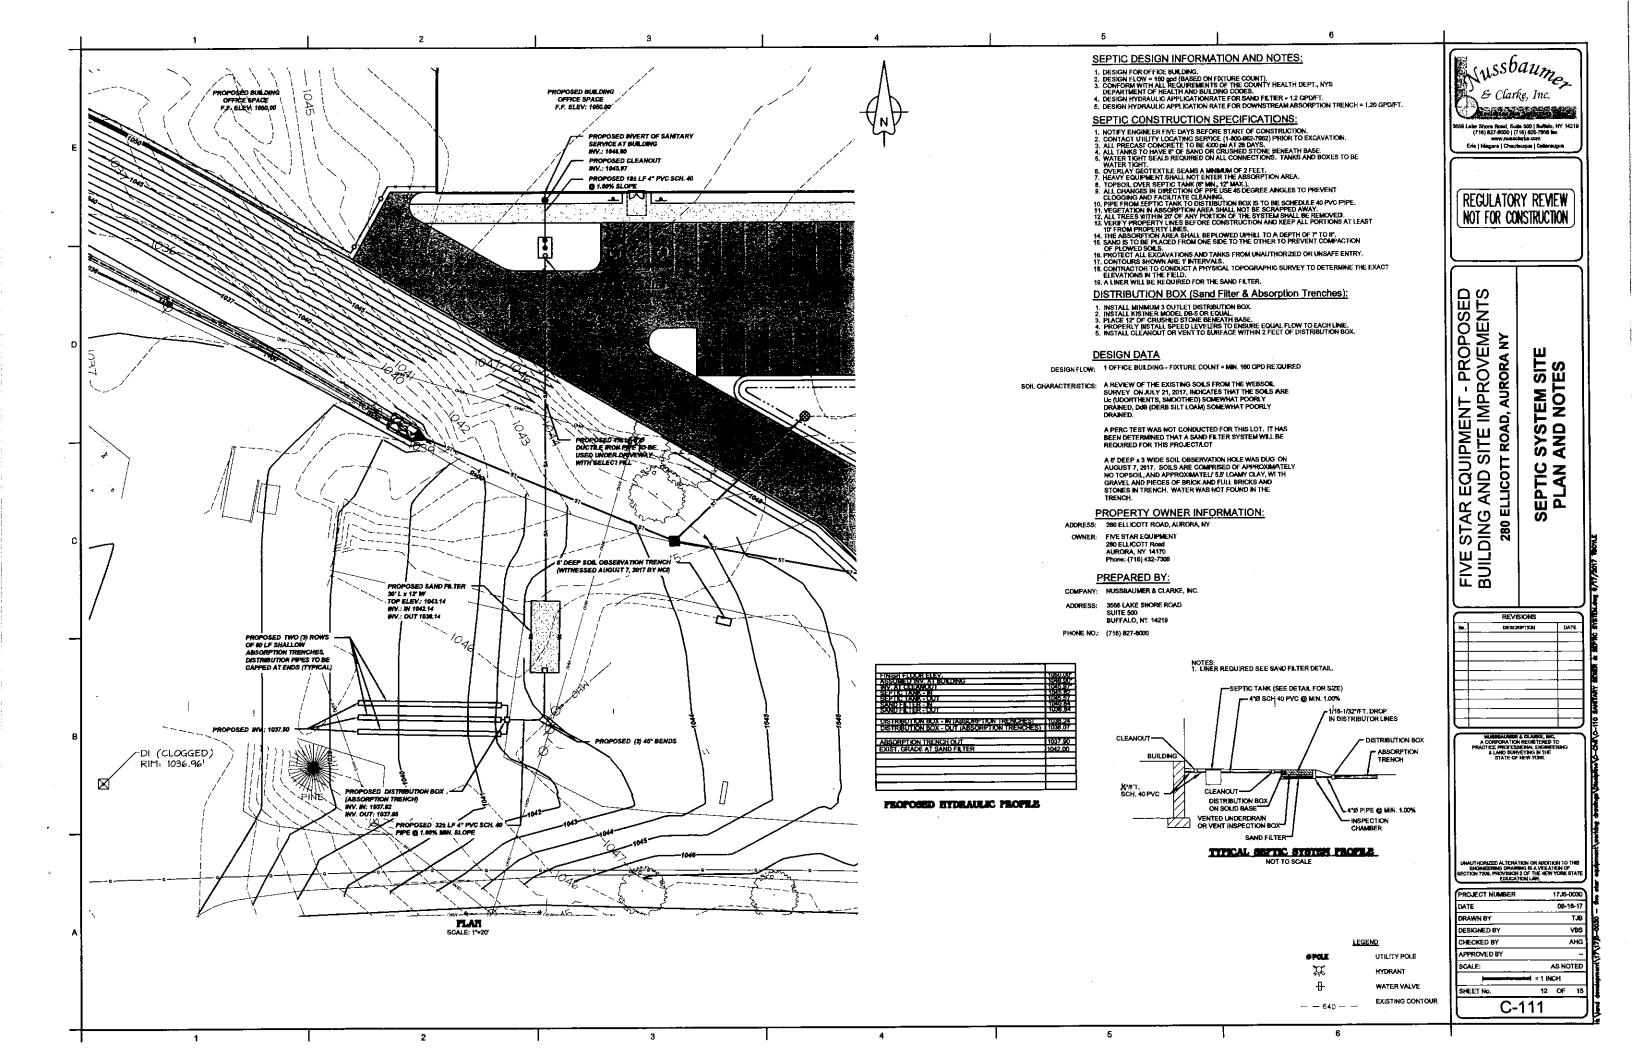


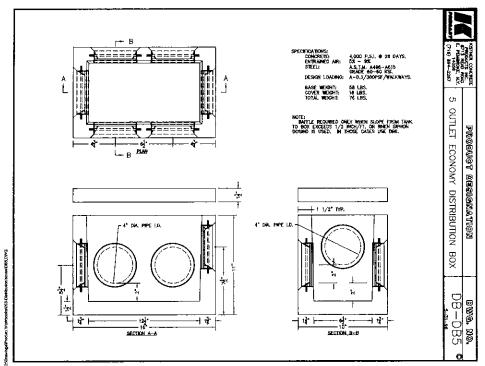

DISTRIBUTION BOX DETAIL NOTES:

DISTRIBUTION BOX

- 1. INSTALL MIN-9 OUTLET DISTRIBUTION BOX.
 2. INSTALL KISTNER MODEL DB-5 OR EQUAL (SEE DETAIL).
 3. ANY OUTLET NOT UTILIZED SHALL 98 SEALED WATERTIGHT.
 4. PLACE 12" OF CRUSHED STONE BENEATH BASE.
 6. PROPERLY HISTALL SPEED LEVELERS TO ENSURE EQUAL FLOW TO EACH LIME.
 6. INSTALL VENT TO SURFACE WITHIN 2 FEET OF DISTRIBUTION BOX.

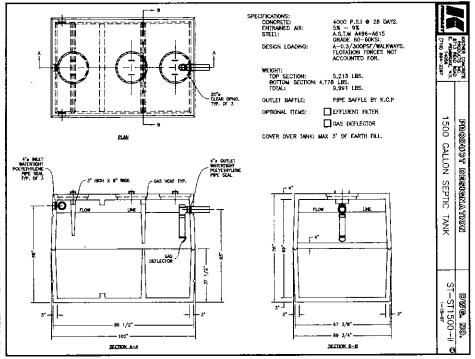


SEPTIC TANK DETAIL NOTES:

- KISTNER MODEL ST1500Z-N OR EQUAL.
 TWO COMPARTMENT 1500 GALLON TANK.
 INLET AND OUTLET WATER TIGHT SEALS
 REQUIRED.
 SURFACE AREA 39 FT².
 INSTALL EFFLUENT FILTER IN SEPTIC TANK
 OUTLET

- 6. COVER SEPTIC TANK AND COVERS WITH 8"
- OF TOPSOIL
 LOCATE TANK 10' MIN, FROM HOUSE,
 INSTALL CLEANOUT BETWEEN TANK AND
 DISTRIBUTION BOX.

1500 GALLON SEPTIC TANK

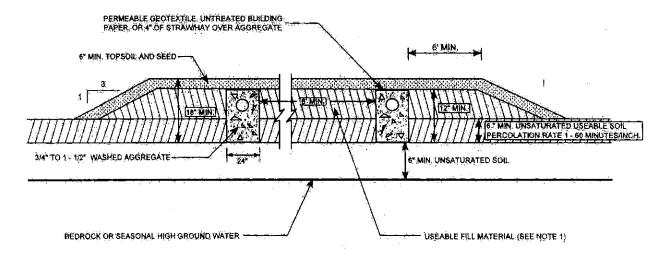


- 1. Sufficient soil similar to the insitu permeable soil shall be provided to essure a trench depth of alleast 18 inches with a minimum one (1) foot depth of aggregate filled.
- aldewall contecting permeable soil and at least 5 inches of aggregate filled sidewall in the permeable insitu soil.

 2. Trenches shall be located at least 20 feet from drainage diliches.
- Trenches should be as long as possible to minimize parallel trenches.
 Distributor length shall not exceed 80 feet for gravity flow and 100 feet for pressure distribution.

FIGURE 35: DOWNSTREAM "MODIFIED" SHALLOW ABSORPTION TRENCH SYSTEM

SHALLOW ABSORPTION TRENCH

NOT TO SCALE

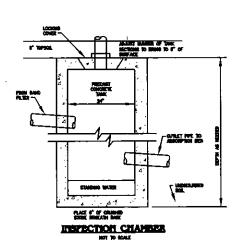

wssbaume, & Clarke, Inc.

> REGULATORY REVIEW NOT FOR CONSTRUCTION


FIVE STAR EQUIPMENT - PROPOSED BUILDING AND SITE IMPROVEMENTS 280 ELLICOTT ROAD, AURORA NY ETAIL ST SY EPTIC

REVISIONS

PROJECT NUMBER 17J5-0030 08-18-17 VBS DRAWN BY DESIGNED BY VBS CHECKED BY AHG APPROVED BY AS NOTED

= 1 INCH

13 OF 1 C-112

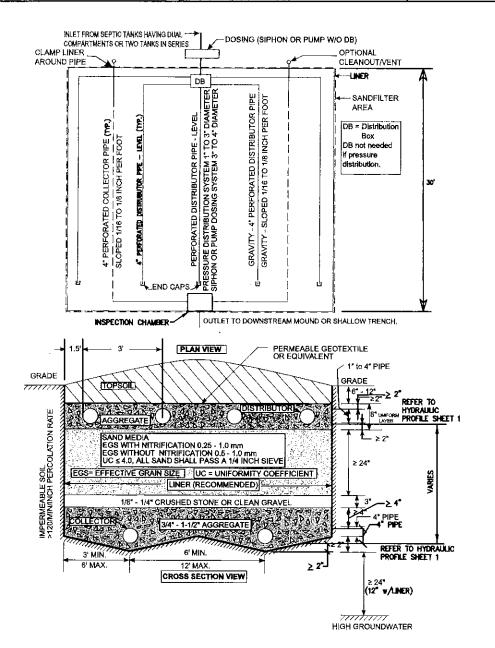

NOTES:

- 1, . Collector illnes to be centered between distributor lines.
- 2. Gravity distribution may be used to apply effluent to small filters having less than 300 lineal feet of distributor or less than 900 square feet of filter area

TYPICAL SAND FILTER DETAIL NOT TO SCALE



REGULATORY REVIEW NOT FOR CONSTRUCTION

FIVE STAR EQUIPMENT - PROPOSED BUILDING AND SITE IMPROVEMENTS 280 ELLICOTT ROAD, AURORA NY DETAILS SYSTEM SEPTIC

12		REVISIONS					
∄⊢							
1112	ko.	DESCRIPTION	DATE				
ш	1						
۱H	+						
H⊢	+		1				
11-		· · · ·					
Ⅱ⊢							
\parallel L							
ΗL							
П	\sqcap						
П	1-						
11	+						
1		<u> </u>					
	, MI	USSBAUMER & CLARKE, R	NC.				

C-113					
SHEET No.	14 OF	16			
<u> </u>	= 1 [NCH				
CALE: AS NOTED					
APPROVED BY		_			
CHECKED BY AHG		AHG			
DESIGNED BY		VBS			
DRAWN BY	VBS				
DATE	08-1	8-17			
PROJECT NUMBER	17J5-	2030			

