

## SURVEY NOTES - THE GOW SCHOOL

BOUNDARY AND TOPOGRAPHIC INFORMATION WAS TAKEN FROM THE FOLLOWING:

TITLE "TOPOGRAPHIC SURVEY PREPARED FOR A PORTION OF THE LANDS OF THE GOUI SCHOOL, TOUN OF AURORA, COUNTY OF EIRE STATE OF NEU YORK PREPARED BY JACOBS LAND SURVEYING, SESS UEST ROAD, MUNISVILLE, NY 19409, TEL: (3)8:495-1114, DATED FEBRUARY 25, 2022.

#### MAP REFERENCES:

I) "TOPOGRAPHIC SURVEY FOR THE GOW SCHOOL" TOWN OF WALES, COUNTY OF ERIE, STATE OF NEW YORK, PREPARED BY NUSSBAUMER & CLARKE, INC, DATED FEBRUARY 22, 1988,

2) "PART OF L.2, T.9, R.6" TOWN OF AURORA, COUNTY OF ERIE, STATE OF NEW YORK, PREPARED BY PAUL G. PAGANO, PL.5, DATED NOVEMBER 28, 2018.

#### MAP NOTES:

3) THIS SURVEY WAS PREPARED WITHOUT THE BENEFIT OF AN UPDATED ABSTRACT OR TITLE REPORT AND IS THEREFORE SUBJECT TO ANY EASEMENTS, COVENANTS, OR RESTRICTIONS OF RECORD OF ANY FACTS SUCH DOCUMENTS WOULD DISCLOSE.

#### BENCHMARKS:

BM-1 : CHISELED 'X' MARK ON TOP OF CONCRETE PAD AT SOUTHJEST CORNER LOCATED AT NORTHJEST CORNER OF ORTON HALL ELEV. = 926.41

### SURVEY VERIFICATION/COORDINATION -THE GOW SCHOOL

CONTRACTOR IS RESPONSIBLE FOR VERFICATION / COORDINATE OF ALL NEORYATION (PENCHYLARS), ELEVATIONS, UTILITIES, ELEPINTS, TREES, ETC. HOUND N. THIS SURVEY AND CALLIBRATINS THIS NEORYATION WITH ACTUAL, IN THE FIELD DATA. THIS SURVEY IS PROVIDED FOR THE BENEFIT OF THE CONTRACTOR AND GENERAL DESIGN HITSET IS SHOUN NO ATOMIC AND EVER AND FIELD DATA VARS.

EXISTING	PROPOSED	DESCRIPTION
	CLL	CONTRACT LIMIT LINE
	MATCHLINE	MATCHLINE
		STREET LINE / PROPERTY EDGE
100		CONTOUR
		GRANITE CURB
		PAVEMENT EDGE
		SAUCUT LINE
	+++++	CURB REMOVAL
	11111	UTILITY REMOVAL
—онw	//////	OVERHEAD WIRES
w	6"W	WATER LINE
- G		GAS LINE
— TEL ——		BURIED TELEPHONE LINE
- E		BURIED ELECTRIC LINE
- SAN	→ SAN →	SANITARY SEWER - SIZE / TYPE
- ST	6" ST	STORM SEWER - SIZE / TYPE
	→ 8" SMT →	STORMWATER MANAGEMENT TRENCH
@		IRON ROD FOUND
-0-		UTILITY POLE
000	⊕ 61	CATCH BASIN / STORM INLET
® (5) [II	⊞ AD	AREA DRAIN
	_	
	● MH	STORM MANHOLE
WW		WINDOW WELL
L.S.		LANDSCAPE AREA
000		CLEANOUT
○ RD	RD	ROOF DRAIN
AC		AIR CONDITIONING UNIT
EM		ELECTRIC METER
GM I		GAS METER
OSV		SEPTIC VENT
<b>⊕</b> FFE		FINISH FLOOR ELEVATION
	-	SIGN
IAIN LINK FENCE	8' CL. FENCE	VINYL CLAD CHAIN LINK FENCE
257.25	456.50	SPOT GRADE
257.25		
	F.V.	FIELD VERIFY
	TYP	TYPICAL FOOTING DRAIN
	FD PD	FOOTING DRAIN PERIMETER DRAIN
	TC/BC	TOP/BOTTOM OF CURB
	TC/BC T5/B5	TOP/BOTTOM OF STAIR
	LFE	LOWER FINISH ELEVATION
	~	TREE REMOVAL
	<u></u>	
* 00		TREES / SHRUBS
	0	DETAIL FLAG
		CONSTRUCTION NOTE
		REMOVE EXISTING PAVEMENT
		REMOVE ASPHALT TO SUBBASE
	3333333333	31/3" ASPHALT ON EX. COMPACTED SUBB
	MDA	MEDIUM DUTY ASPHALT
	HDA	HEAVY DUTY ASPHALT
	d HDC d	HEAVY DUTY CONCRETE WITH SCORING
		STANDARD CONCRETE WITH SCORING
		LAWN TYPE I -4" TOPSOIL, SEED AND MU



Ph: 716.842.1800 www.youngarch.com

Consultants







Project information

HOWARD HALL

THE GOW SCHOOL 2485 EMERY ROAD SOUTH WALES, NY 14139

NOT FOR CONSTRUCTION


Issue I	Issue Date: 11-25-22			
Revisi	Revisions			
Rev.	Date	Description		
1	11/15/22	SITE PLAN REVIEW		
	-	-		
	-	-		
	-	-		
	-	-		
	-	-		
	-	-		
Projec	t No. 180	08		
Drawn	Ву			
Copyrig	ht 2022, Yo	ung Architectural, LLC		

Sheet Title

SURVEY

LAWN TYPE 2 - 4" TOPSOIL, SEED AND STRAW MAT

C100 **GOW** 

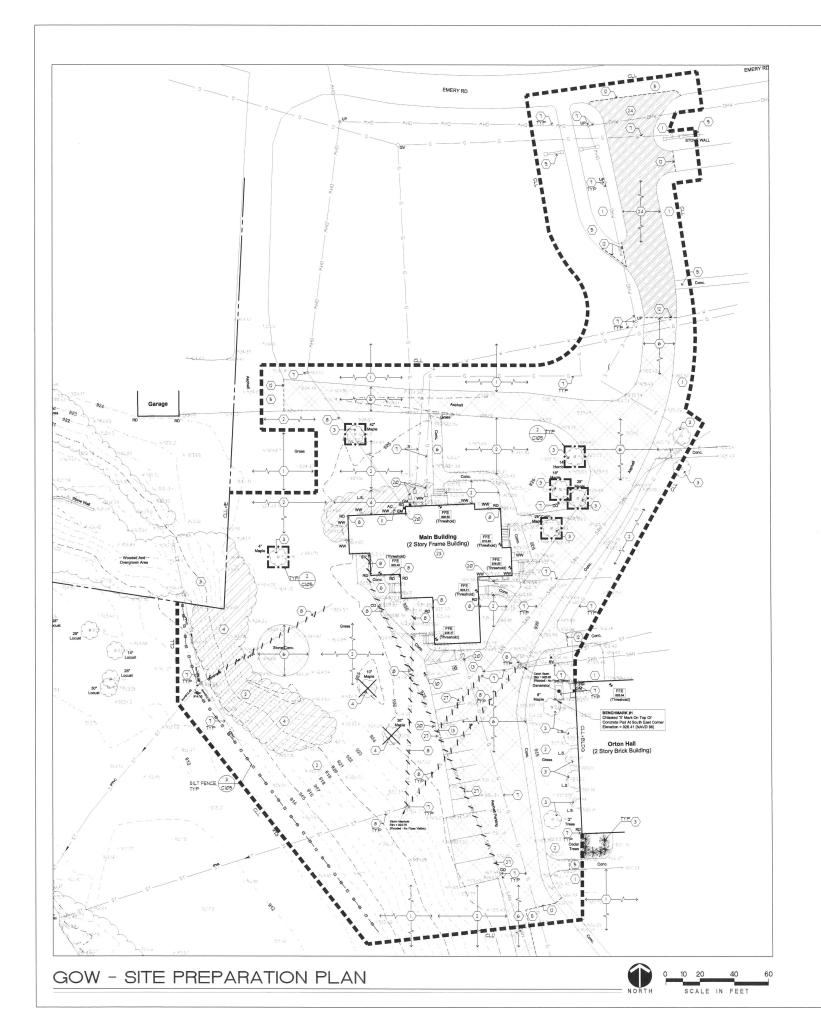

# SITE PREPARATION and CONSTRUCTION NOTES - THE GOW SCHOOL

- EXISTING LAWN AREA REMAINS, PROTECT.
- $\fbox{2}$  strip existing topsoil and stock pile for reuse onsite in an area as shoun on plans or as directed by the owner temporarily seed entire pile immediately and surround with silt fence.
- (3) EXISTING VEGETATION REMAINS, PROTECT AT ALL TIMES AS SHOWN ON THE PLANS AND AS SPECIFIED, DO NOT PARK VEHICLES/EQUIPMENT OR STORE MATERIALS WITHIN DRIP LINES OF TREES.
- 4 REMOVE EXISTING VEGETATION, INCLUDING ALL STUMPS AND ROOTS AND DISPOSE OFF SITE BACKFILL VOID WITH IMPORTED GRANULAR BACKFILL COMPACTED TO MINIMAY 95% OF INCLUDE DEDBITY.
- (5) EXISTING PAVEMENT REMAINS, PROTECT, REPLACE ANY PAVEMENT DAMAGED DURING CONSTRUCTION OPERATIONS,
- (6) REMOVE EXISTING PAVEMENT SURFACE AND HAIL OFF SITE OR MILL AND USE AS GENERAL EARTH FILL UNEN NEETING SPECIFIED SIEVE REQUIREMENTS. REMOVE GRANULAR PLASE COURSE AND HAIL, OF SITE OR USE AS GENERAL EARTH FILL UNEN MEETING SPECIFIED SIEVE REQUIREMENTS.
- 1 EXISTING SITE UTILITY REMAINS, PROTECT.
- (B) REMOVE EXISTING SITE UTILITY & DISPOSE OFF SITE, BACK FILL VOID WITH IMPORTED GRANULAR BACKFILL, COMPACTED TO MINIMUM 95% OF IN PLACE DRY DENSITY.
- 9 EXISTING SITE FEATURE REMAINS, PROTECT.
- (Ø) REMOVE EXISTING SITE FEATURE AND DISPOSE OFF SITE, INCLUDING ANY ASSOCIATED FOOTINGS OR UNDERDRAINS. BACKFILL VOID WITH IMPORTED GRANULAR BACKFILL COMPACTED TO 95% OF IN PLACE DRY DENSITY.
- II) REMOVE EXISTING SITE FEATURE AND RETURN TO OWNER.
- (12) SAW CUT NEAT, STRAIGHT EDGE PRIOR TO PAVING AT CONCRETE SIDEWALKS REMOVE AT NEAREST SCORE JOINT.
- (B) VERIFY LOCATION, ELEVATION, INVERT AND TYPE OF EXISTING PIPE PRIOR TO CONSTRUCTION, NOTIFY LANDSCAPE ARCHITECT OF ANY DISCREPANCY WITH SURVEY OR PROPOSED WORK.
- (4) ADJUST UTILITY TO FINISHED GRADE.
- (B) MEET EXISTING LINE AND GRADE.
- (6) SLIP DOUEL NEW CONCRETE WALK INTO EXISTING CONCRETE WALK OR BUILDING FOUNDATION WALL WITH NO. 4 SLIP DOUBL, 19" LONG, 12" OC, 2" CLEAR MINIMINE FROM SURFACE, INSERT DOUBLS EQUAL LENGTH INTO EXISTING AND NEW CONCRETE. PROVIDE EXPANSION JOINT AND SEALANT.
- ALIGN NEW EDGE WITH EXISTING.
- (IB) CAP END SILT TIGHT.
- (9) PROVIDE HOT TAR ASPHALT CRACK SEALER BETWEEN EXISTING AND NEW ASPHALT JOINT.
- DISCONNECT UTILITY PRIOR TO DEMOLITION OF BUILDING. COORDINATE WORK WITH OWNER 4 APPLICABLE UTILITY COMPANY.

  (2) PROVIDE FERNICO COUPLER OR SIMILAR SILT TIGHT JOINT BETWEEN EXISTING
- (2) PROVIDE FERNCO COUPLER OR SIMILAR SILT TIGHT JOINT BETILEEN EXISTING PIPE AND RUST STORM FIPE ALLOUI INSPECTION BY ARCHITECT PRIOR TO BACKFILLING, NOTIFY ARCHITECT WERN EACH YT D BACKFILL WERN CONNECTING DISSIMILAR PIPES, PROVIDE MARKIAC DISSIMILAR PIPE COUPLER.
- (2) CORE INTO EXISTING STRUCTURE TO ALLOW INSTALLATION OF PROPOSED PIPE MORTAR VOID BETWEN OFFISION OF PIPE WALL TO STRUCTURE EDE MATERIAL TO STRUCTURE FOR MATERIAL TO STRUCTURE FOR HEAD PIPE AND THE PIPE TO STRUCTURE FOR HEAD PIPE TO STRUCTURE FOR HEAD PIPE TO STRUCTURE TO TO STR
- (3) EXISTING BUILDING TO BE DEMOLISHED, INCLUDING FOUNDATION. COORDINATE WITH OURSE AND IDENTEY ITEM TO BE SALVAGED, REPOVE ALL DEBRIS 1 LEGALLY DISPOSE OF THE COORDINATE UTILITY DISCONSICIONS WITH APPLICABLE WILLIY COMPANY. BACKFILL VOID WITH COMPACTED STRUCTURAL FILL MATERIAL.
- $\begin{picture}(24)\line(24)$
- (25) CLEAN EXISTING ASPHALT PAVEMENT SURFACE PRIOR TO ASPHALT OVERLAY, PROVIDE ASPHALT CRACK FILLER ON PAVEMENT CRACKS OR SEAMS.
- (26) NSTALL PIPE TO WITHIN FIVE REET OF BUILDING, CAP ENDS FLIMBING CONTRACTOR TO MAKE FINAL CONNECTION OF BUILDING SYSTEM TO SITE WILLTY SYSTEM COORDINATE ALL WORK AND INVERTS WITH FLIMBING CONRACTOR PRIOR TO STARTING BUSING.
- 27) MAINTAIN SANITARY SEWER UNTIL NEW SERVICE IS COMPLETE.
- (28) CONTRACTOR SHALL FIELD LOCATE CONTINUATION OF STORM PIPEUNDERDRAINAGE. REPORT FINDINGS TO ARCHITECT.



Ph: 716.842.1800

www.youngarch.com

A red seal and a blue signature indicates an original document.

Consultants



Engineering, P.C.
Buffelo • Rochester
Mechanical • Electrical
Communications
Tri-Main Center
2495 Main St, Suite 318
Buffelo, NY 14214
P. 716.836.2315
F: 716.836.2319





1853 EAST MAIN STREET ROCHESTER, NEW YORK 146 phone (585) 482-813 fax: (585) 482-0440 www.jensenbry.com

Project information

HOWARD HALL

THE GOW SCHOOL 2485 EMERY ROAD SOUTH WALES, NY 14139

NOT FOR CONSTRUCTION

Issue Date: 11-25-22			
Revisi	ons		
Rev.	Date	Description	
1	11/15/22	SITE PLAN REVIEW	
	-	-	
	-	-	
	-	-	
	-	-	
	-		
	-	-	
Projec	t No. 180	08	
Drawn	Ву		
		ung Architectural, LLC	


Sheet Title


SITE PREPARATION

This is a single sheet of a cohesive set of constructio documents, including drawings and specifications. Interpretation of the information presented is to be based to be an on the entire set of documents.

Sheet No.

C101 gow

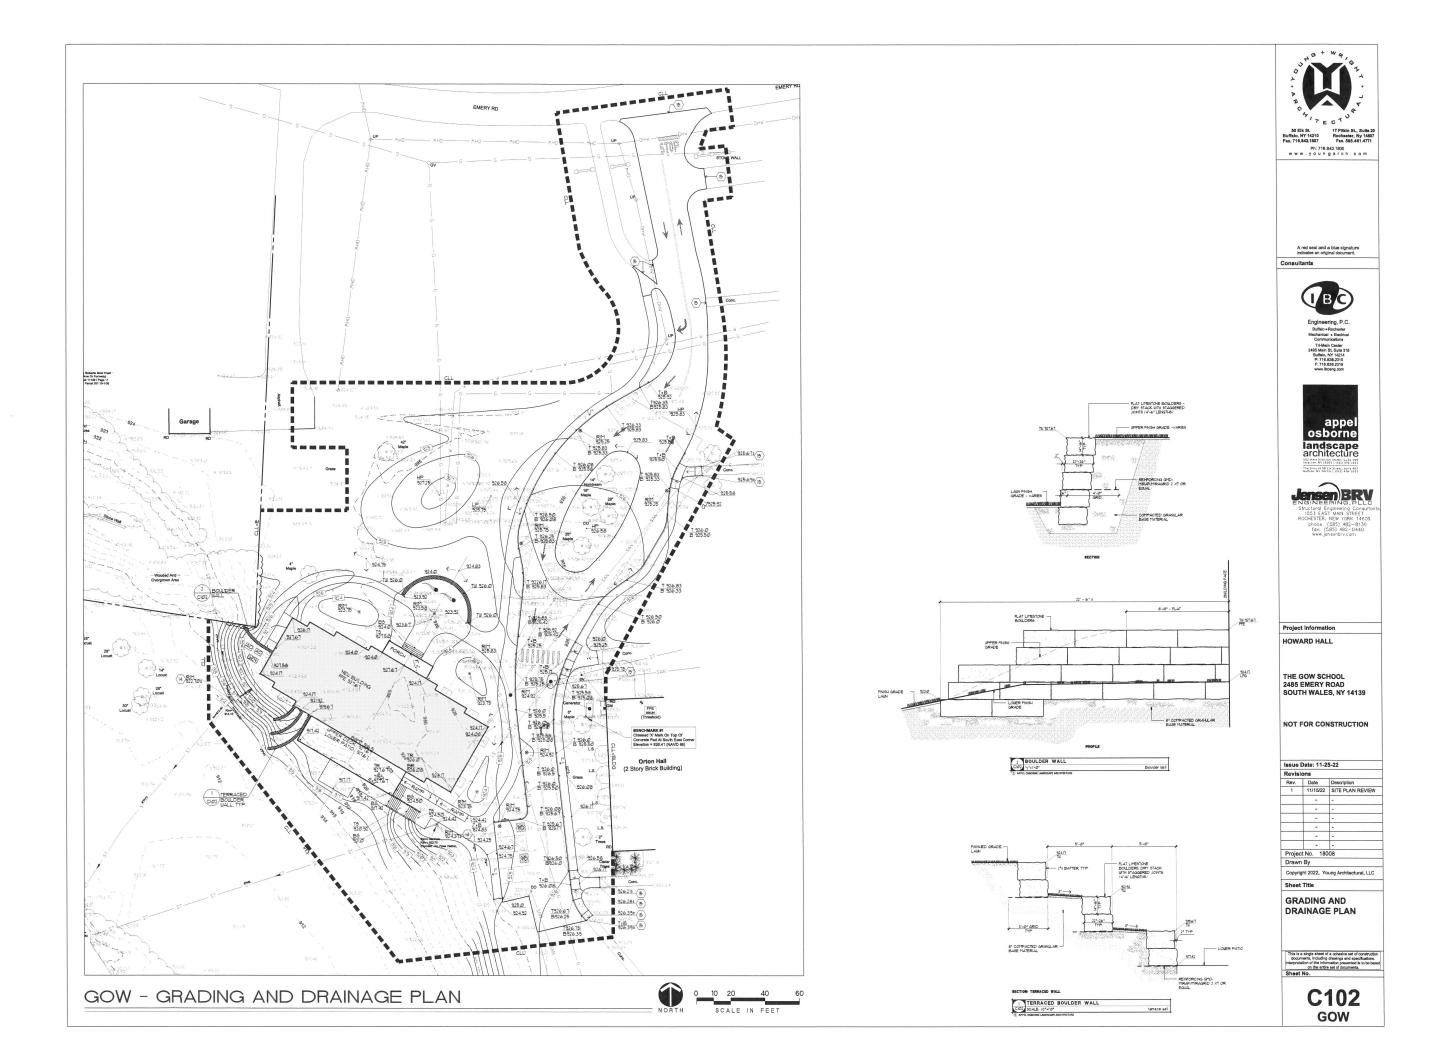

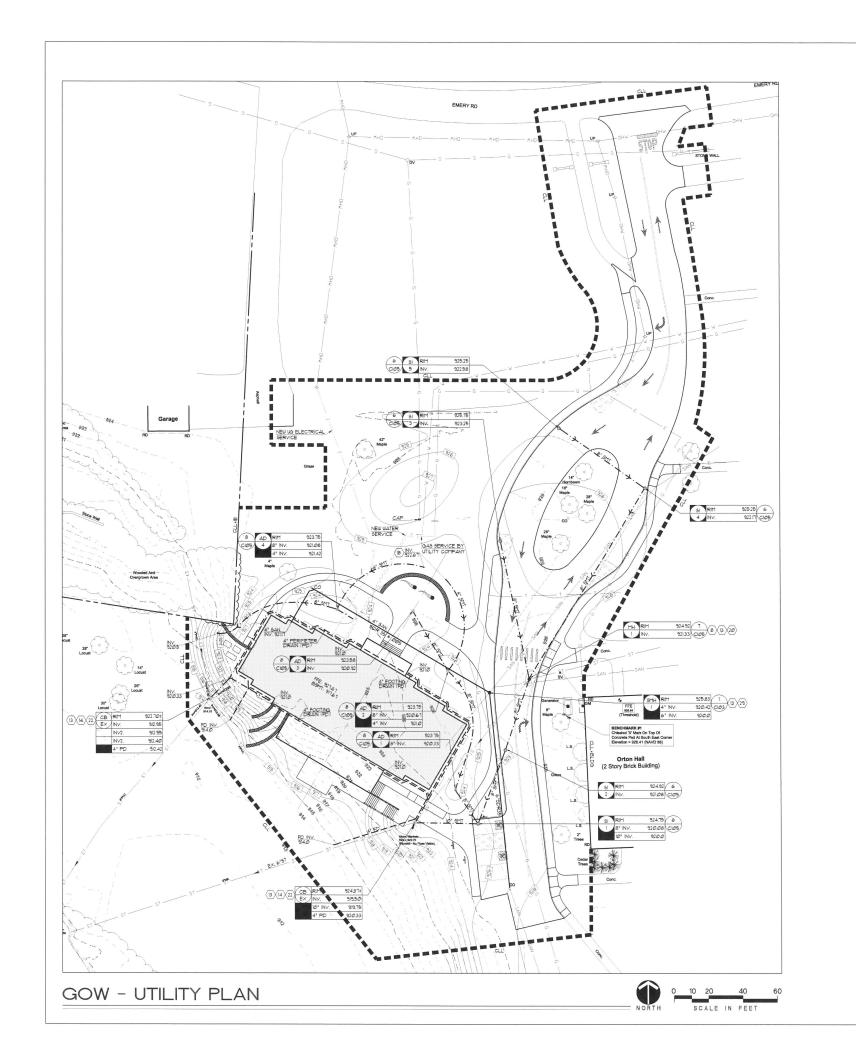



A red seal and a blue signature indicates an original document.

Consultants



Communications
Tri-Main Center
2495 Main St, Suite 3:
Buffalo, NY 14214
P: 716.836.2315
F: 716.836.2319
www.ibcang.com



ENGINEERING, PLLC Structural Engineering Consultor 1653 FAST MAIN STREET

Project Information

HOWARD HALL

THE GOW SCHOOL 2485 EMERY ROAD SOUTH WALES, NY 14139

NOT FOR CONSTRUCTION

Issue Date: 11-25-22				
Revisi	ons			
Rev.	Date	Description		
1	11/15/22	SITE PLAN REVIEW		
	-	-		
	-	-		
		-		
	-	-		
	-	-		
	-	-		
Projec	t No. 180	08		
Drawr	Ву			
Copyrig	ght 2022, Yo	ung Architectural, LLC		
Sheet	Title			

UTILITY PLAN

"O" RING JOINT OR APPROVED ALTERNATE

PROVIDE AND APPLY—
BITUMINOUS COATING
TO ALL EXTERIOR
SURFACES INCLUDING
CORDELL AREA
SLOPE 1/2" ON—
10" EACH SIDE

NOTES.

ALL PRAYES AND COVERS WILL BE ADEQUATE TO BEAR H-JO WEEL LOADS.

SANITARY MANHOLE


SO WEETON NOT TO SCALE

OF METE DISSON EL MOCIMEN AUGUSTERIARS

OF METE DISSON EL MOCIMEN AUGUSTERIARS

This is a single sheet of a cohesive set of construction documents, including drawings and specifications, interpretation of the information presented is to be base on the entire set of documents.

C103 gow

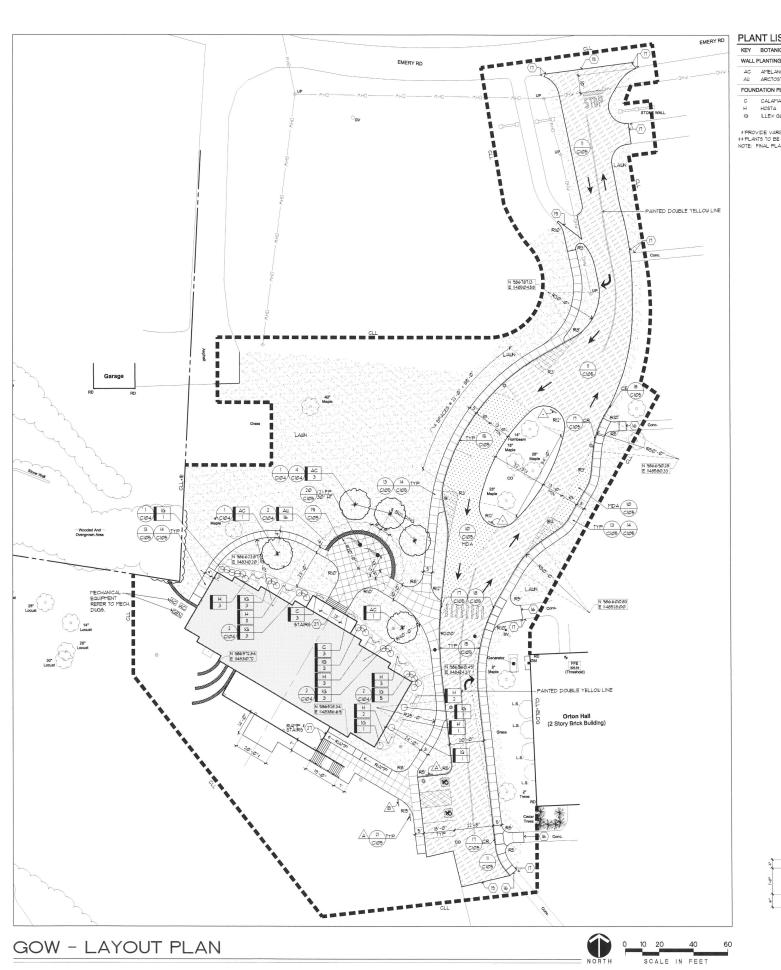

#### PLANT LIST - THE GOW SCHOOL

KEY	BOTANICAL NAME	COMMON NAME	QTY.	ROOT & SIZE **	SPACING	NOTES
WALL	PLANTINGS					
AC	AMELANCHIER CANADENSIS	SERVICEBERRY	5	15'-25' HT.	20' O.C. OR AS SHOWN	
AU	ARCTOSTAPHYLOS UVA-URSI	BEARBERRY	16	2-21/2" CAL.	4' O.C. OR AS SHOWN	
FOUN	IDATION PLANTINGS					
С	CALAMAGROSTIS 'STRICTA'	KARL FOERSTER FEATHER REED GRASS	6	3'-6' HT.	31 O.C. OR AS SHOWN	
Н	HOSTA	HOSTA	17	2-21/2" CAL.	4' O.C. OR AS SHOWN	
G	ILLEX GLABRA	NKEERRY	26	2-21/2" CAL.	4" OC OR AS SHOUN	

\* PROVIDE VARIETY NOTED, DO NOT SUBSTITUTE WITH SPECIES
\*\* PLANTS TO BE BALLED AND BURLAPPED UNLESS NOTED OTHERWISE
NOTE: FINAL PLACEMENT OF PLANTS TO BE FIELD DIRECTED BY ARCHITECT







Jensen BRV

Project Information

HOWARD HALL


THE GOW SCHOOL 2485 EMERY ROAD SOUTH WALES, NY 14139


NOT FOR CONSTRUCTION


Revisi	ons	
Rev.	Date	Description
1	11/15/22	SITE PLAN REVIE
	-	-
	-	-
	-	-
	-	-
	-	-
	-	-
Projec	t No. 180	108
Drawn	1 Ву	

LAYOUT PLAN

C104 **GOW** 

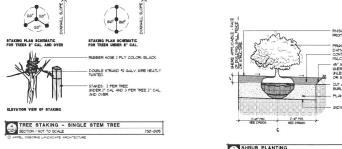

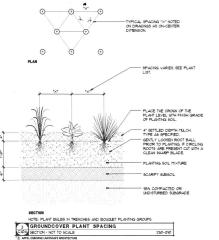


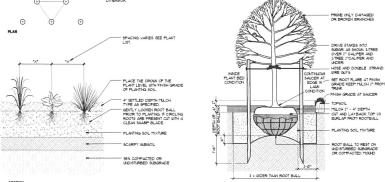

DECIDUOUS TREE PLANTING - SINGLE STEM

GO SECTION - NOT TO SCALE 190-001

G APPEL OSCORE LANDROPE ARCHITECTARE

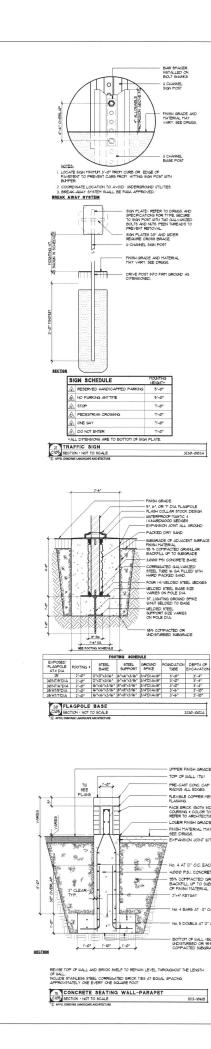

U CHANNEL

323*0-00*3A

323@-@@2A

UPPER FINISH GRADE (UPG) - TOP OF WALL (TW) PRE-CAST CONC. CAP STONE, I RADIUS ALL EDGES.

FLEXIBLE COPPER MEMBRANE FLASHING


LOWER FINISH GRADE (LFG)
FINISH MATERIAL MAY VARY,
SEE DRIVES.

95% COMPACTED GRANULAR BACKFILL UP TO SUBGRADE. OF FINISH MATERIAL

No. 5 DOUBLS AT 12" O.C.


NSION JOINT WITH SEALAN


No. 4 AT IZ" OC FACH WAY BOTHSIDES

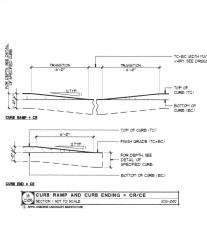








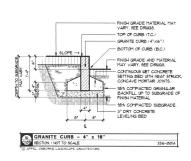

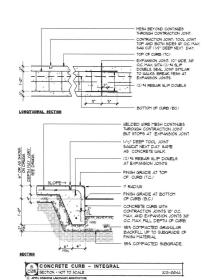


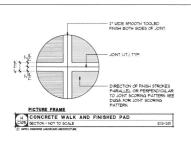


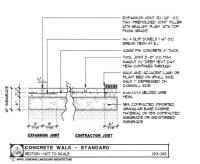

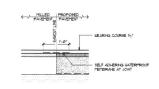





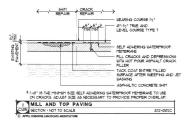


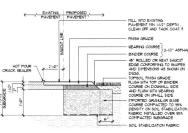





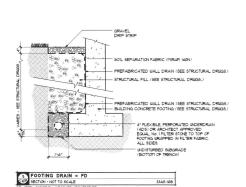


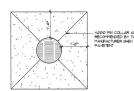


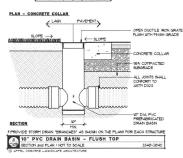


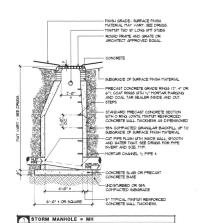


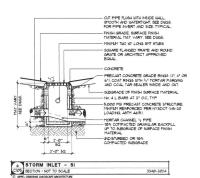

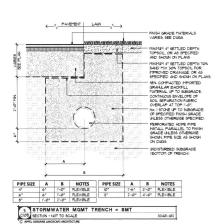


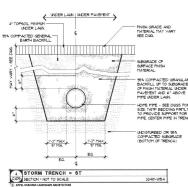


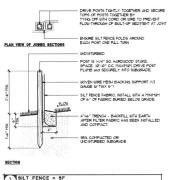

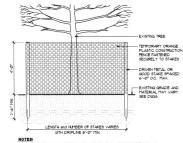



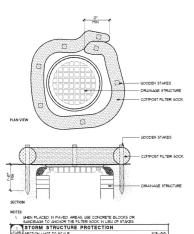

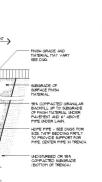

50 Elk St. 17 Pitidn St., Suite 2
Buffalo, NY 14210 Rochester, Ny 14607
Fax. 716.842.1807 Fax. 585.461.4771

A red seal and a blue signature indicates an original document.

**TBC** 

Engineering, P.C.
Buffalo - Rochester
Mechanical - Electrical
Communications
Tri-Main Center
2495 Main St, Suite 318
Buffalo, Ny 14214
P: 716.836.2315
F: 716.836.2319
www.ibceng.com


appel osborne


landscape

architecture


Jensen BRV

Consultants

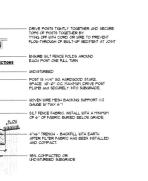

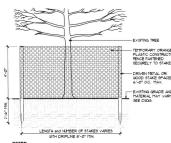



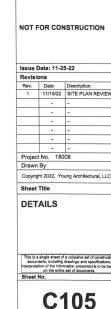



**GOW** 

Project Information HOWARD HALL


THE GOW SCHOOL

2485 EMERY ROAD SOUTH WALES, NY 14139

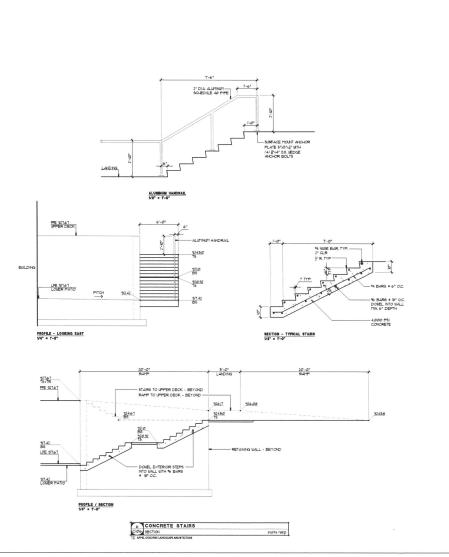

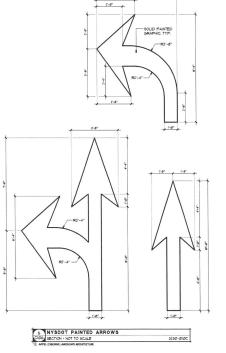




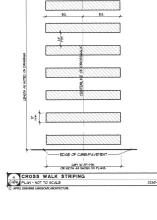






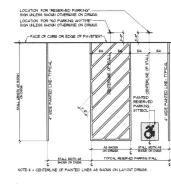



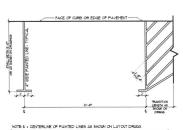

NOTE: 4 - CENTERLINE OF PANTED LINES AS SHOWN ON LAYOUT DRUGS

PARALLEL PARKING STALL MARKING-TYPICAL

CIDS (BECTON: NOT TO SCALE 3336-0098)

C WITS GOOD MICKORY MODIFICIAN





Jensen BRV

Project Information

HOWARD HALL


THE GOW SCHOOL 2485 EMERY ROAD SOUTH WALES, NY 14139


NOT FOR CONSTRUCTION

issue l	Date: 11-2	5-22
Revisi	ons	
Rev.	Date	Description
1	11/15/22	SITE PLAN REVI
	-	-
	-	-
	-	-
	-	-
	-	-
	-	-
Projec	t No. 180	108
Drawn	Ву	

DETAILS

C106 GOW

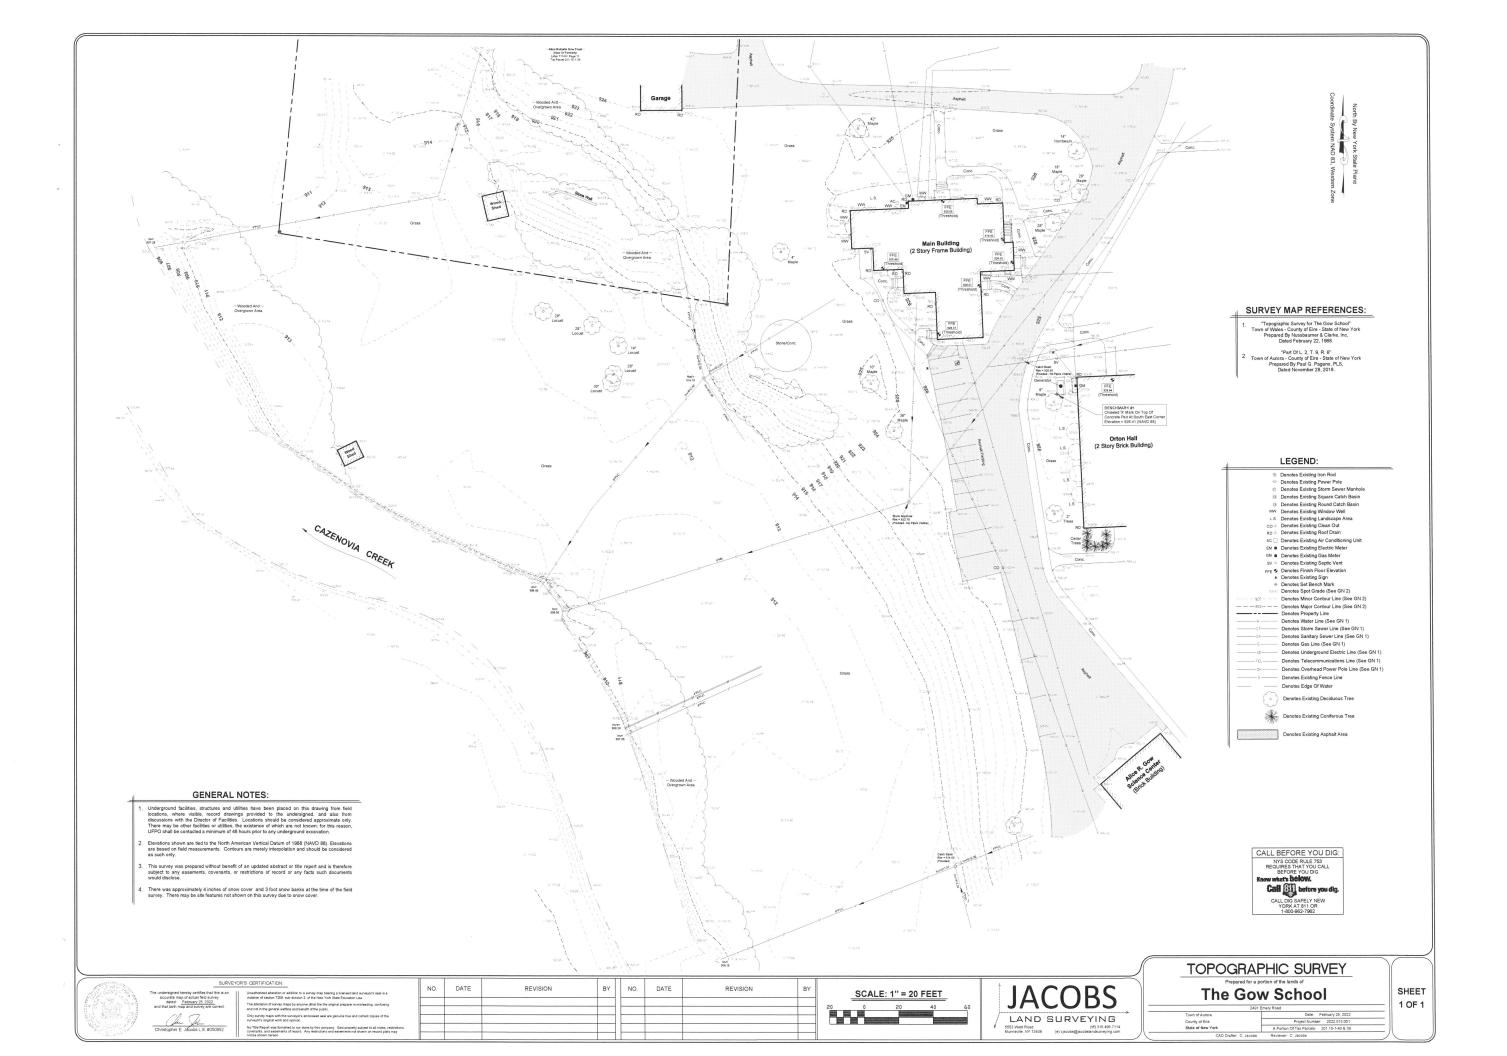

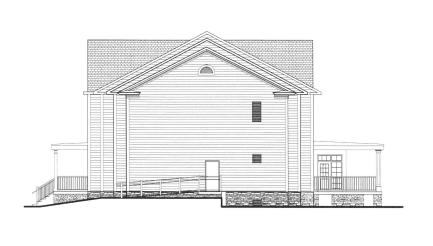





6 BACK PORCH SIDE EXTERIOR ELEVATION
Scale: 1/4" = 1'-0"

5 BACK PORCH EXTERIOR ELEVATION
Scale: 1/4" = 1'-0"

2 EXTERIOR ELEVATION
Scale: 1/8" = 1'-0"



1 EXTERIOR ELEVATION
Scale: 1/8" = 1'-0"

KEY PLAN 2  $\bigcirc$ 





Jensen BRV

Project Information

HOWARD HALL

THE GOW SCHOOL 2485 EMERY ROAD SOUTH WALES, NY 14139

NOT FOR CONSTRUCTION

Revisions				
Rev.	Date	Description		
1	11/15/22	Site Plan Review		
	-	-		
	-	-		
	-	-		
	-	-		
	-	-		
	-	-		

Project No. 18008 Drawn By JN

Copyright 2022, Young Architectural, LLC Sheet Title

EXTERIOR ELEVATIONS

**A201** 

3 EXTERIOR ELEVATION
Scale: 1/8" = 1'-0"

EXTERIOR ELEVATION
Scale: 1/8" = 1'-0"